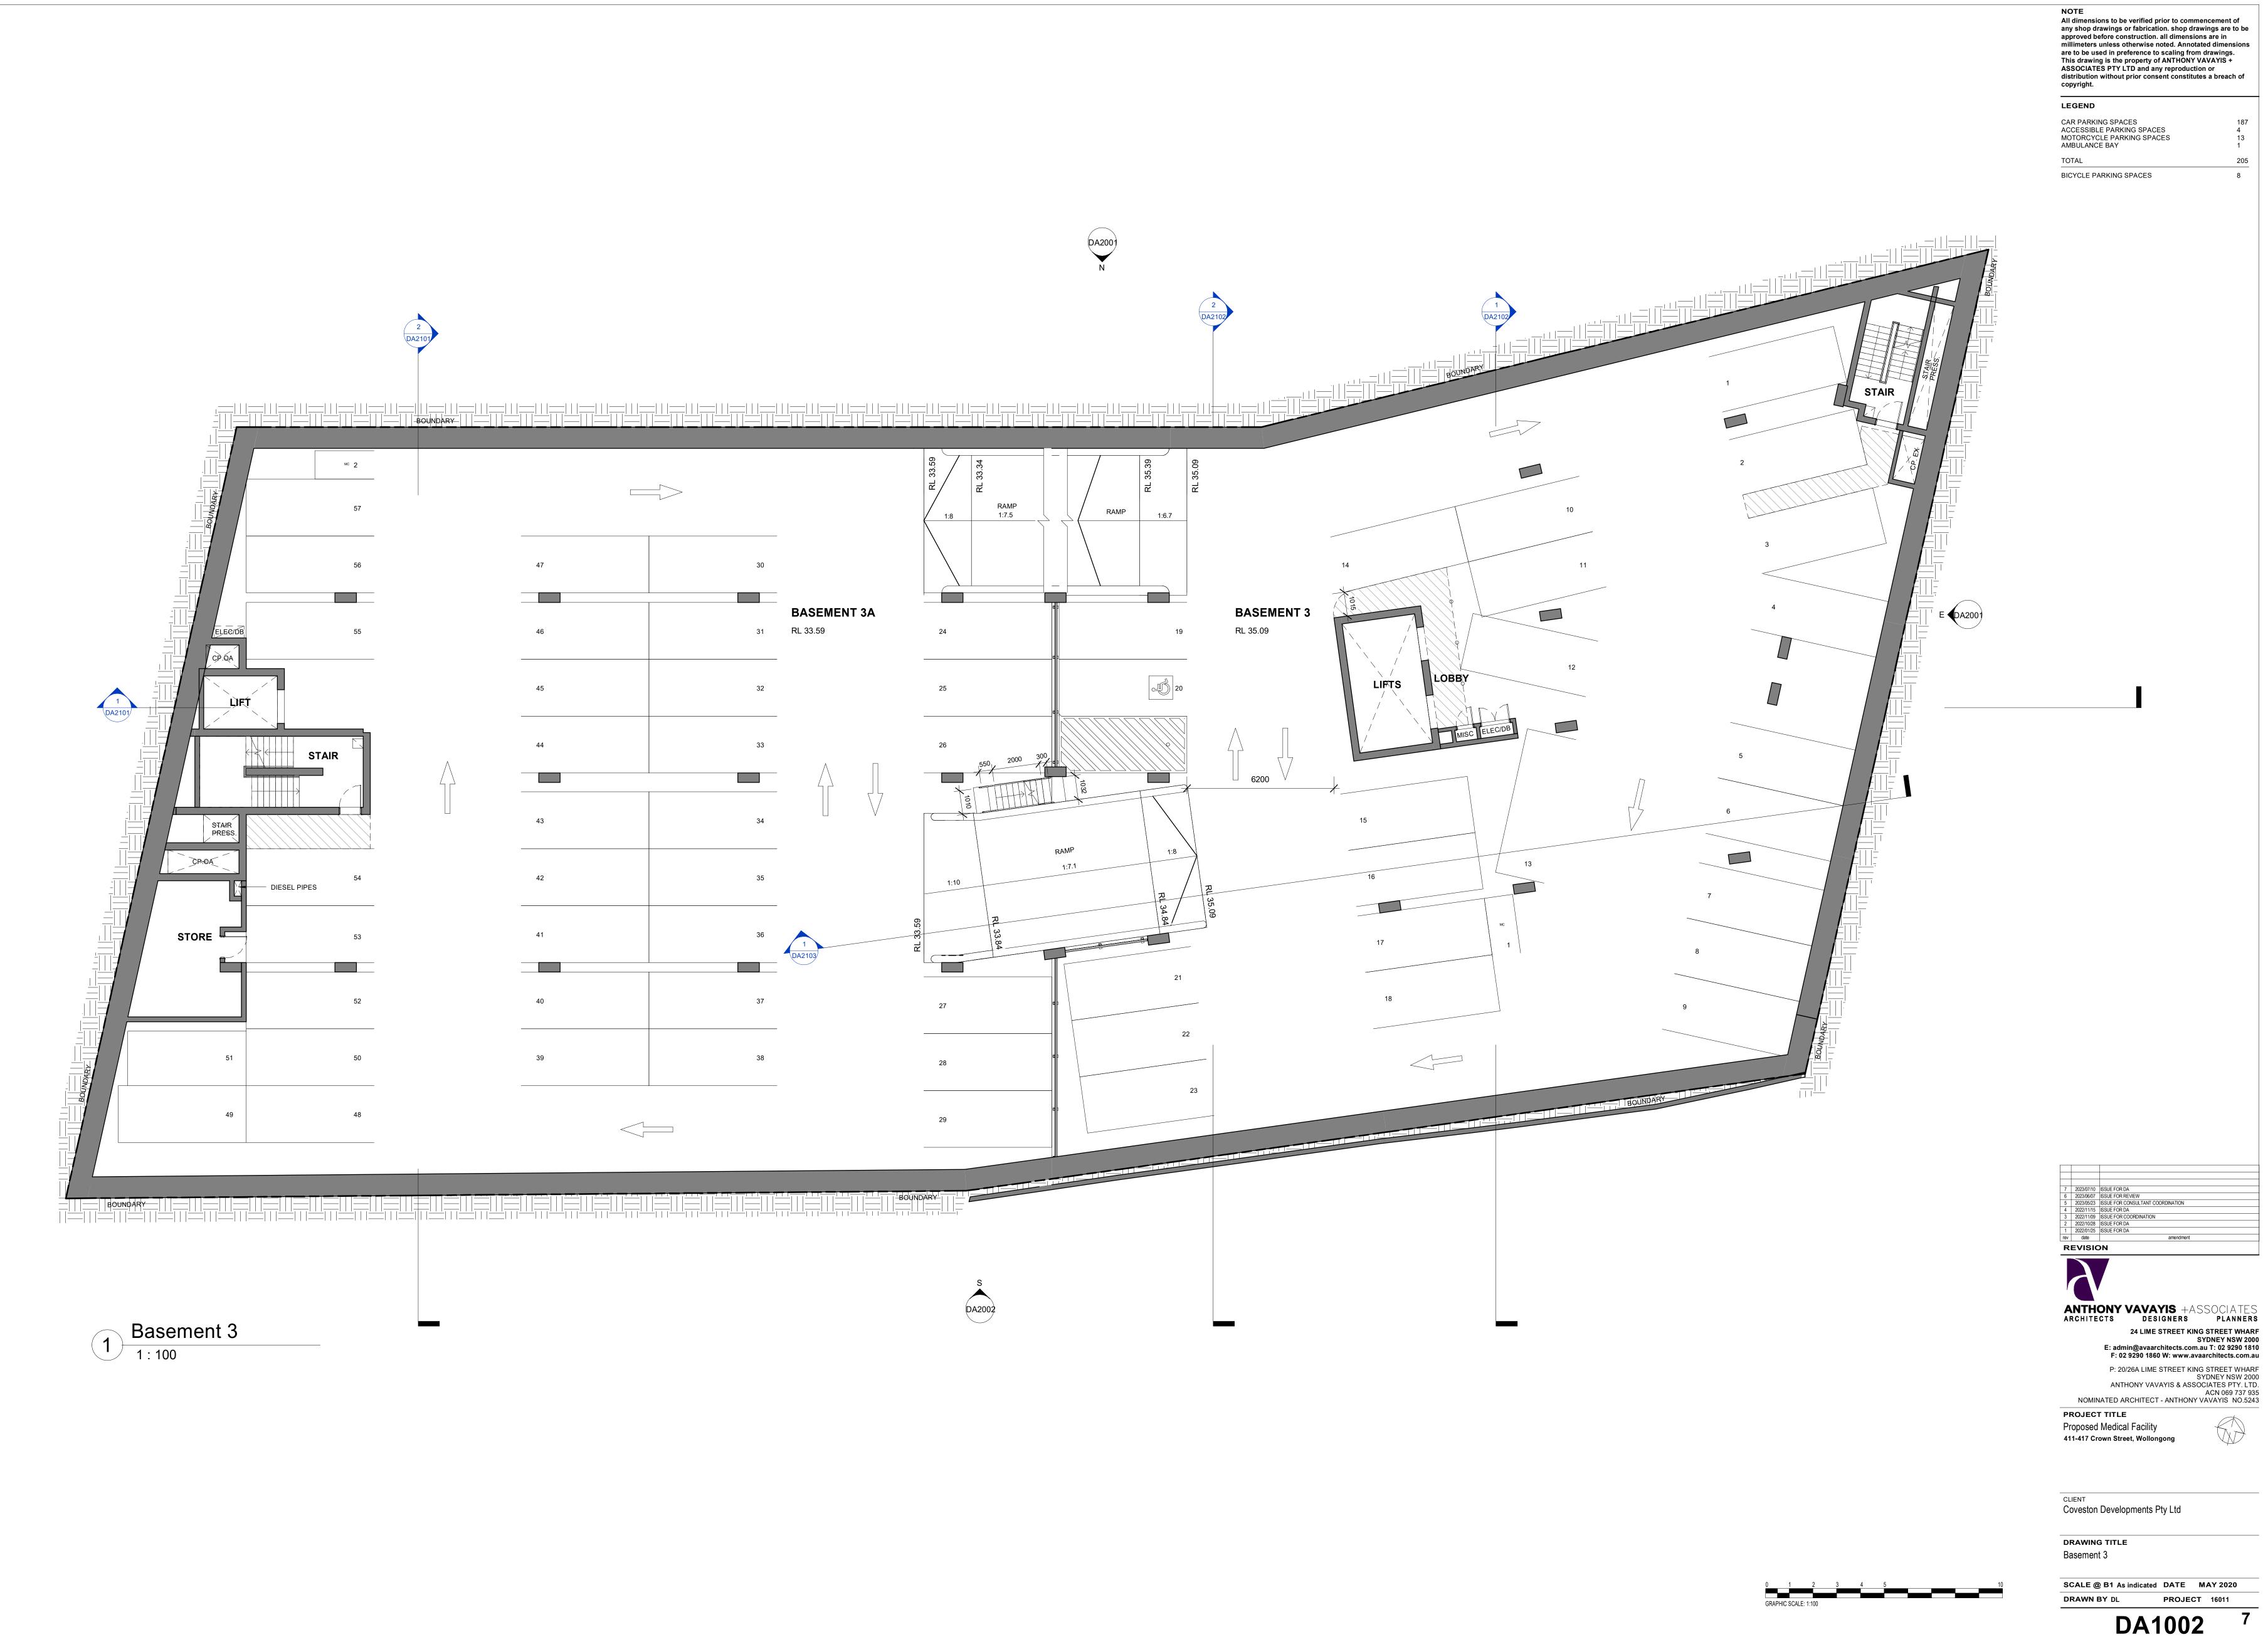



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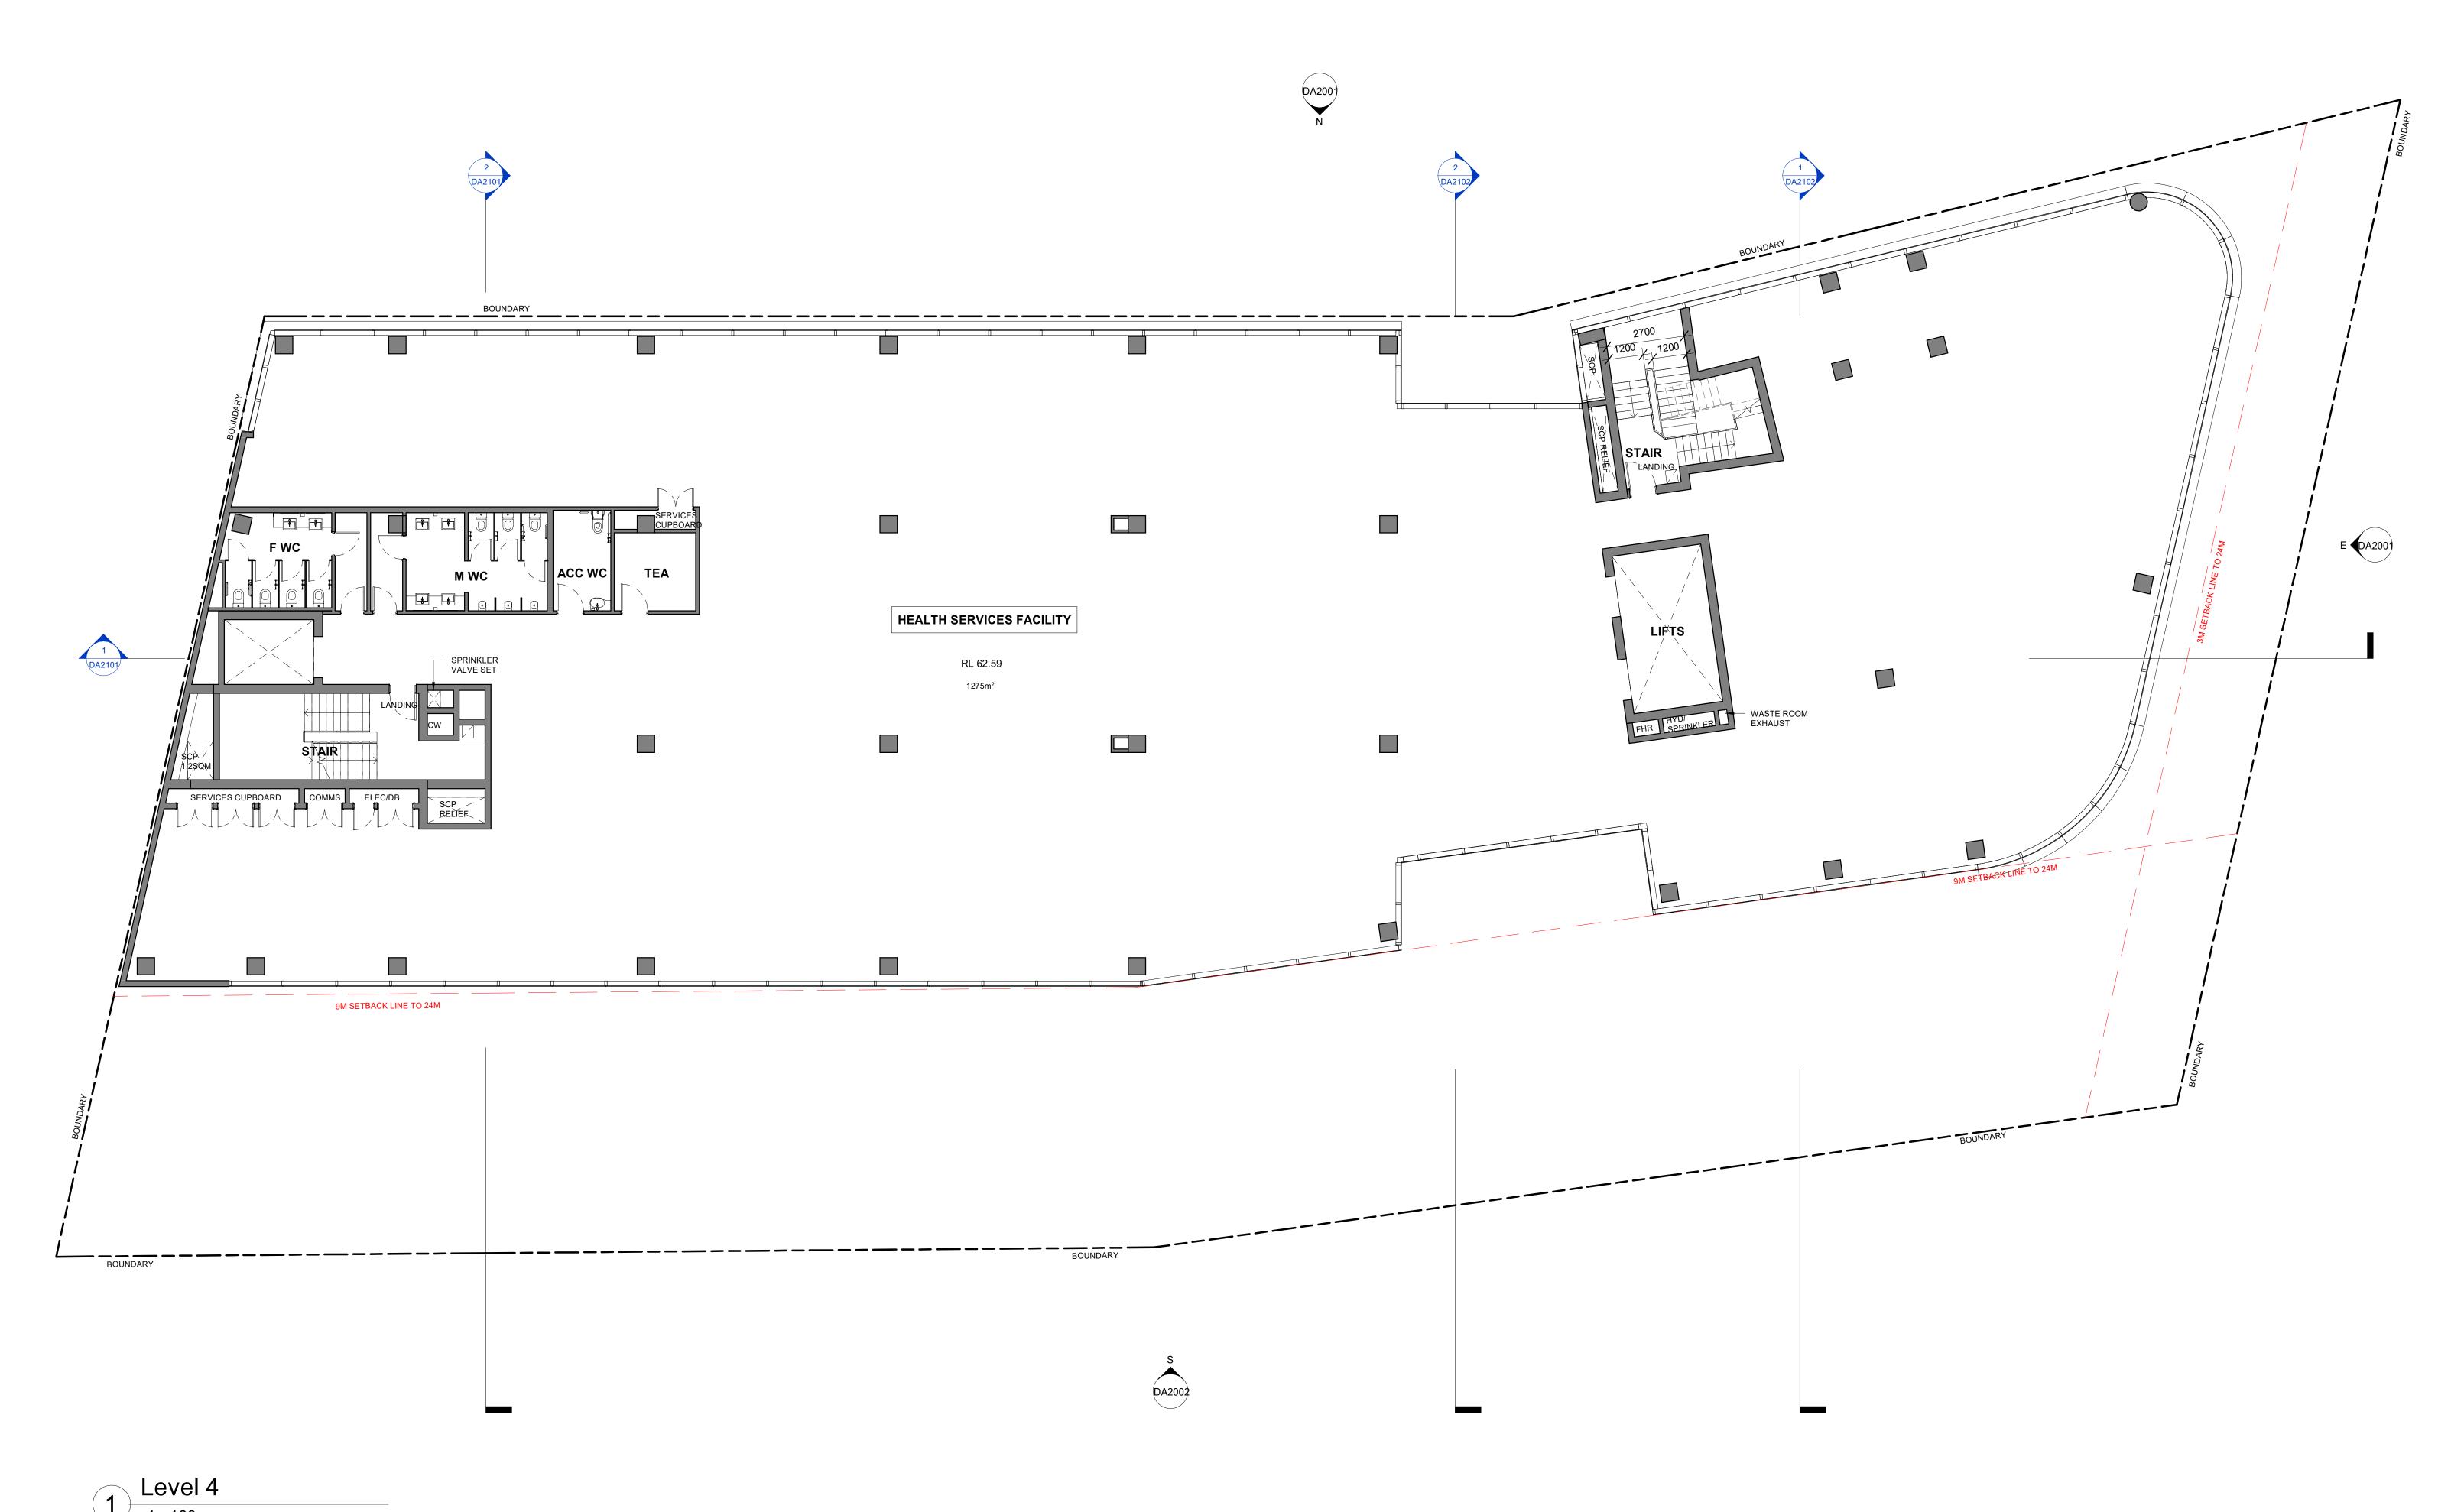
P: 20/26A LIME STREET KING STREET WHARF SYDNEY NSW 2000 ANTHONY VAVAYIS & ASSOCIATES PTY. LTD. ACN 069 737 935 NOMINATED ARCHITECT - ANTHONY VAVAYIS NO.5243 PROJECT TITLE

Proposed Medical Facility 411-417 Crown Street, Wollongong

CLIENT
Coveston Developments Pty Ltd

DRAWING TITLE Level 3

LEGEND

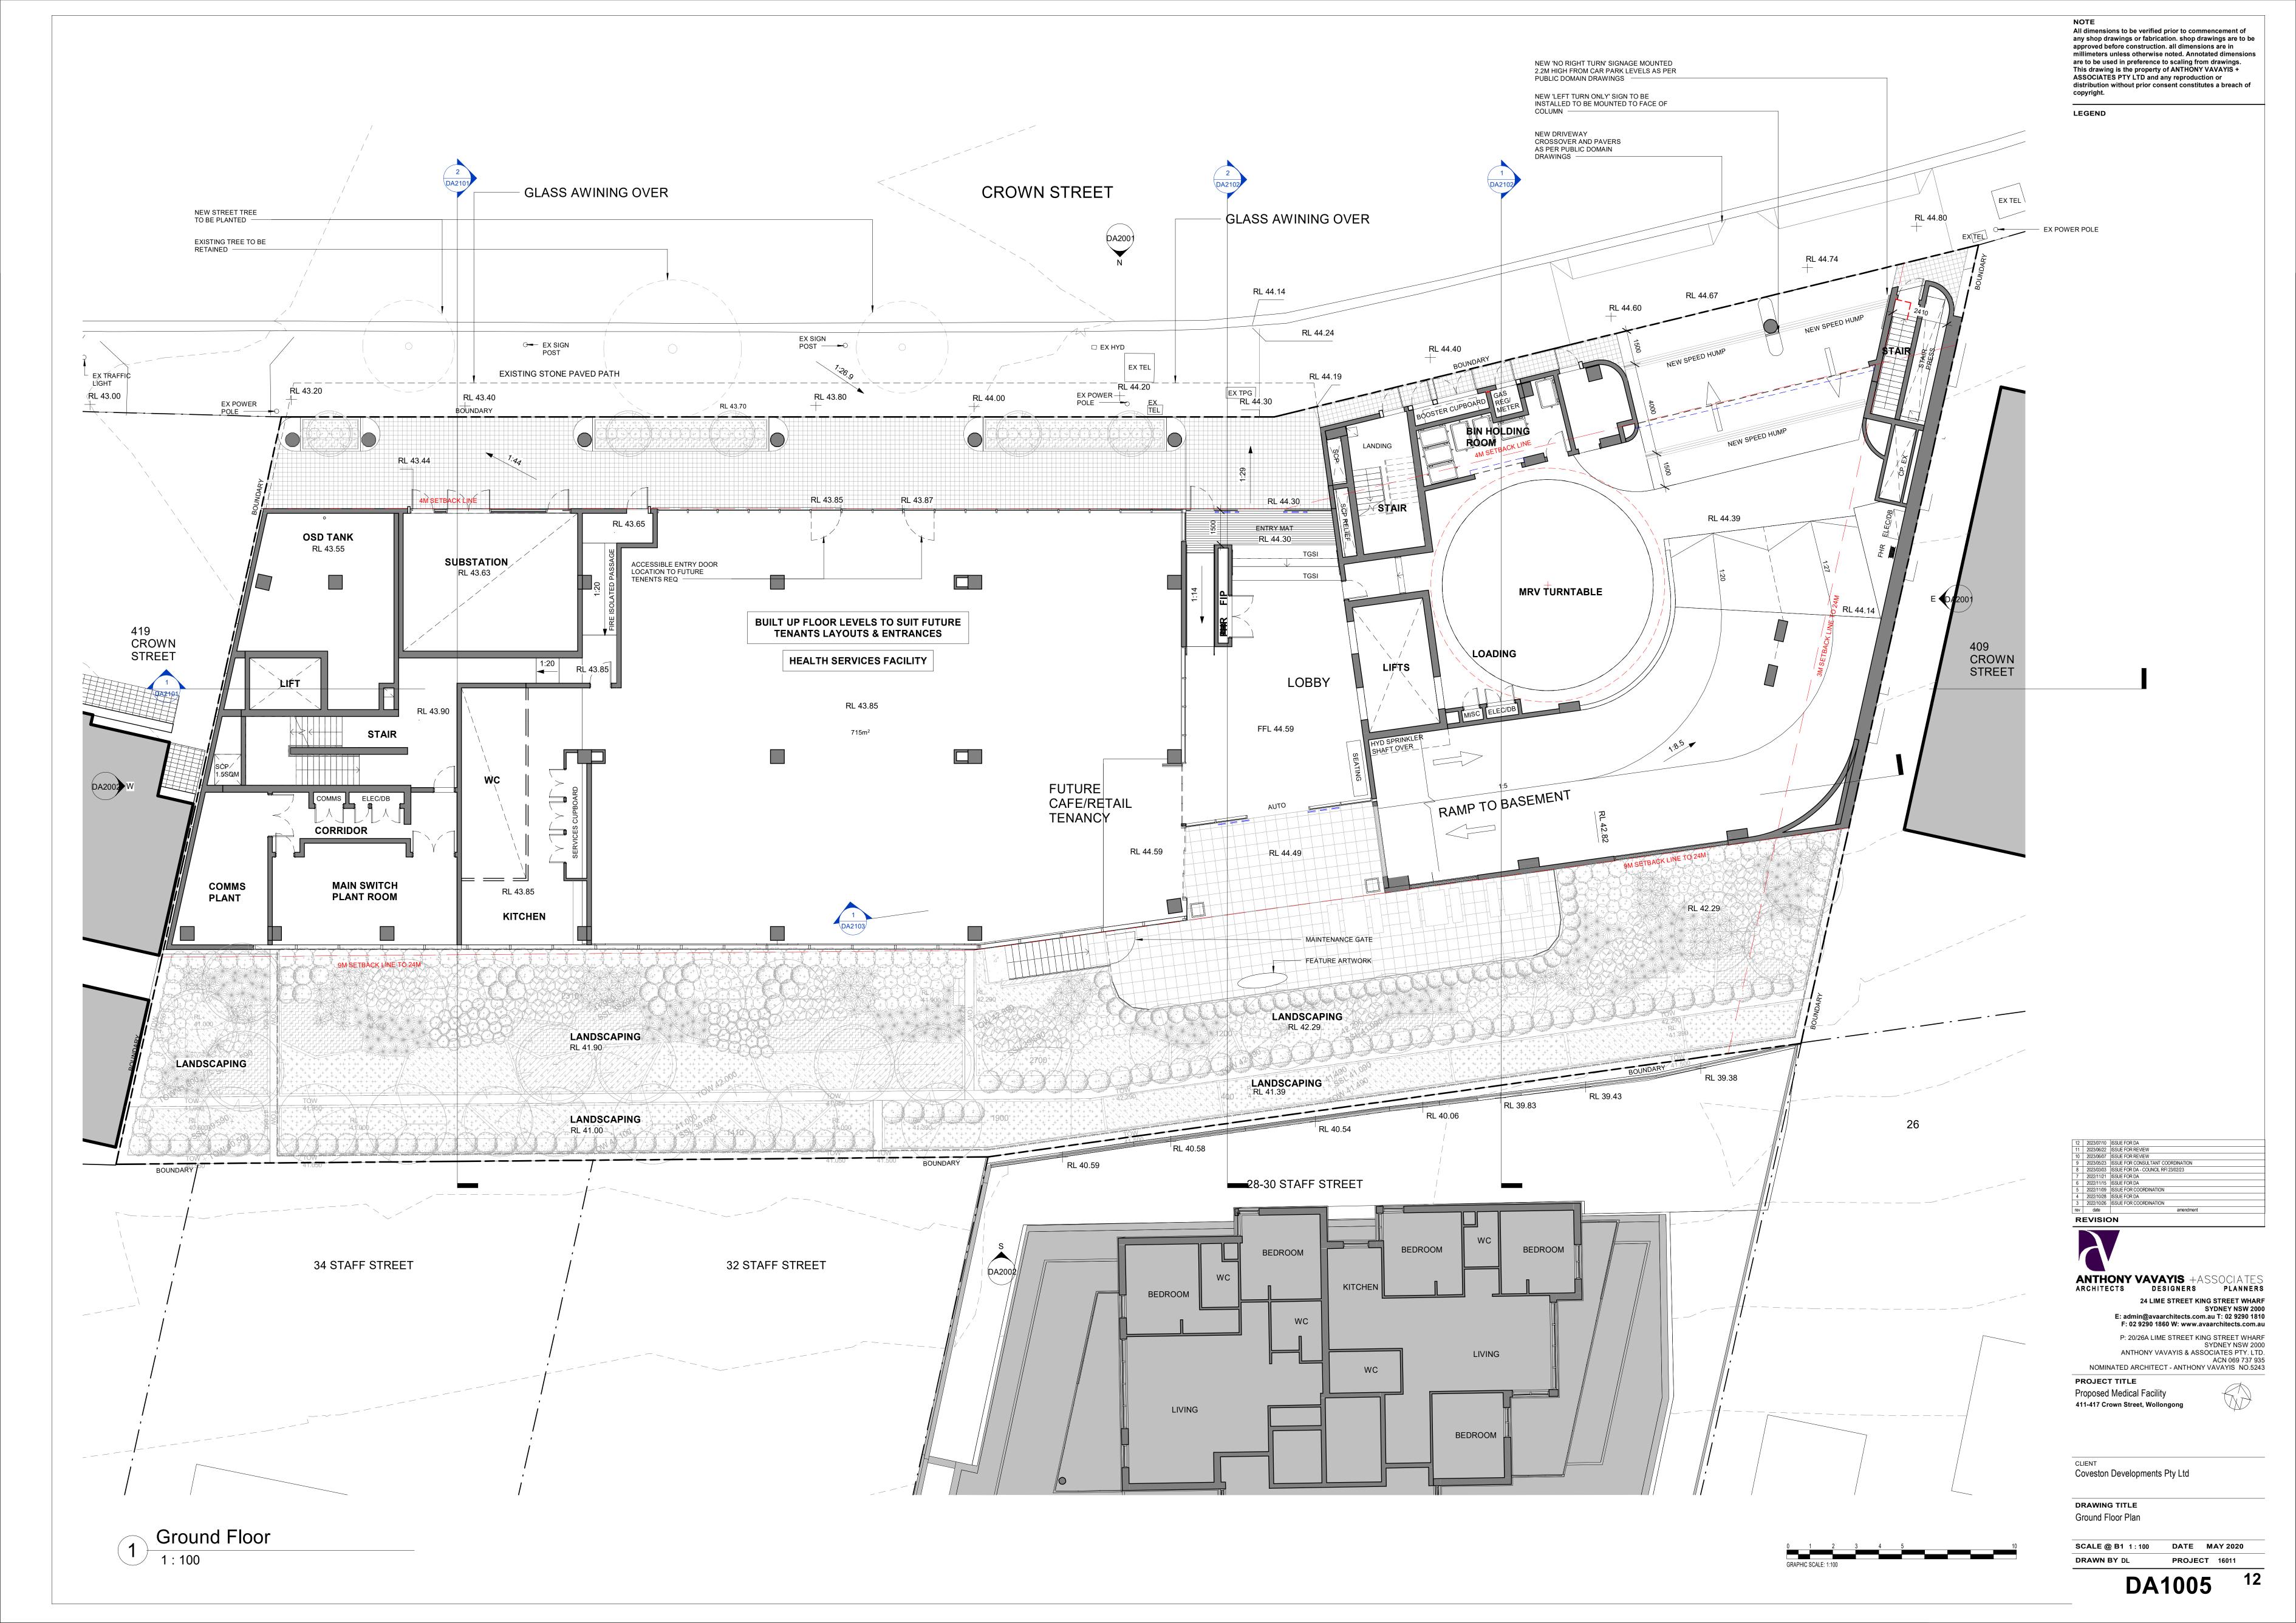

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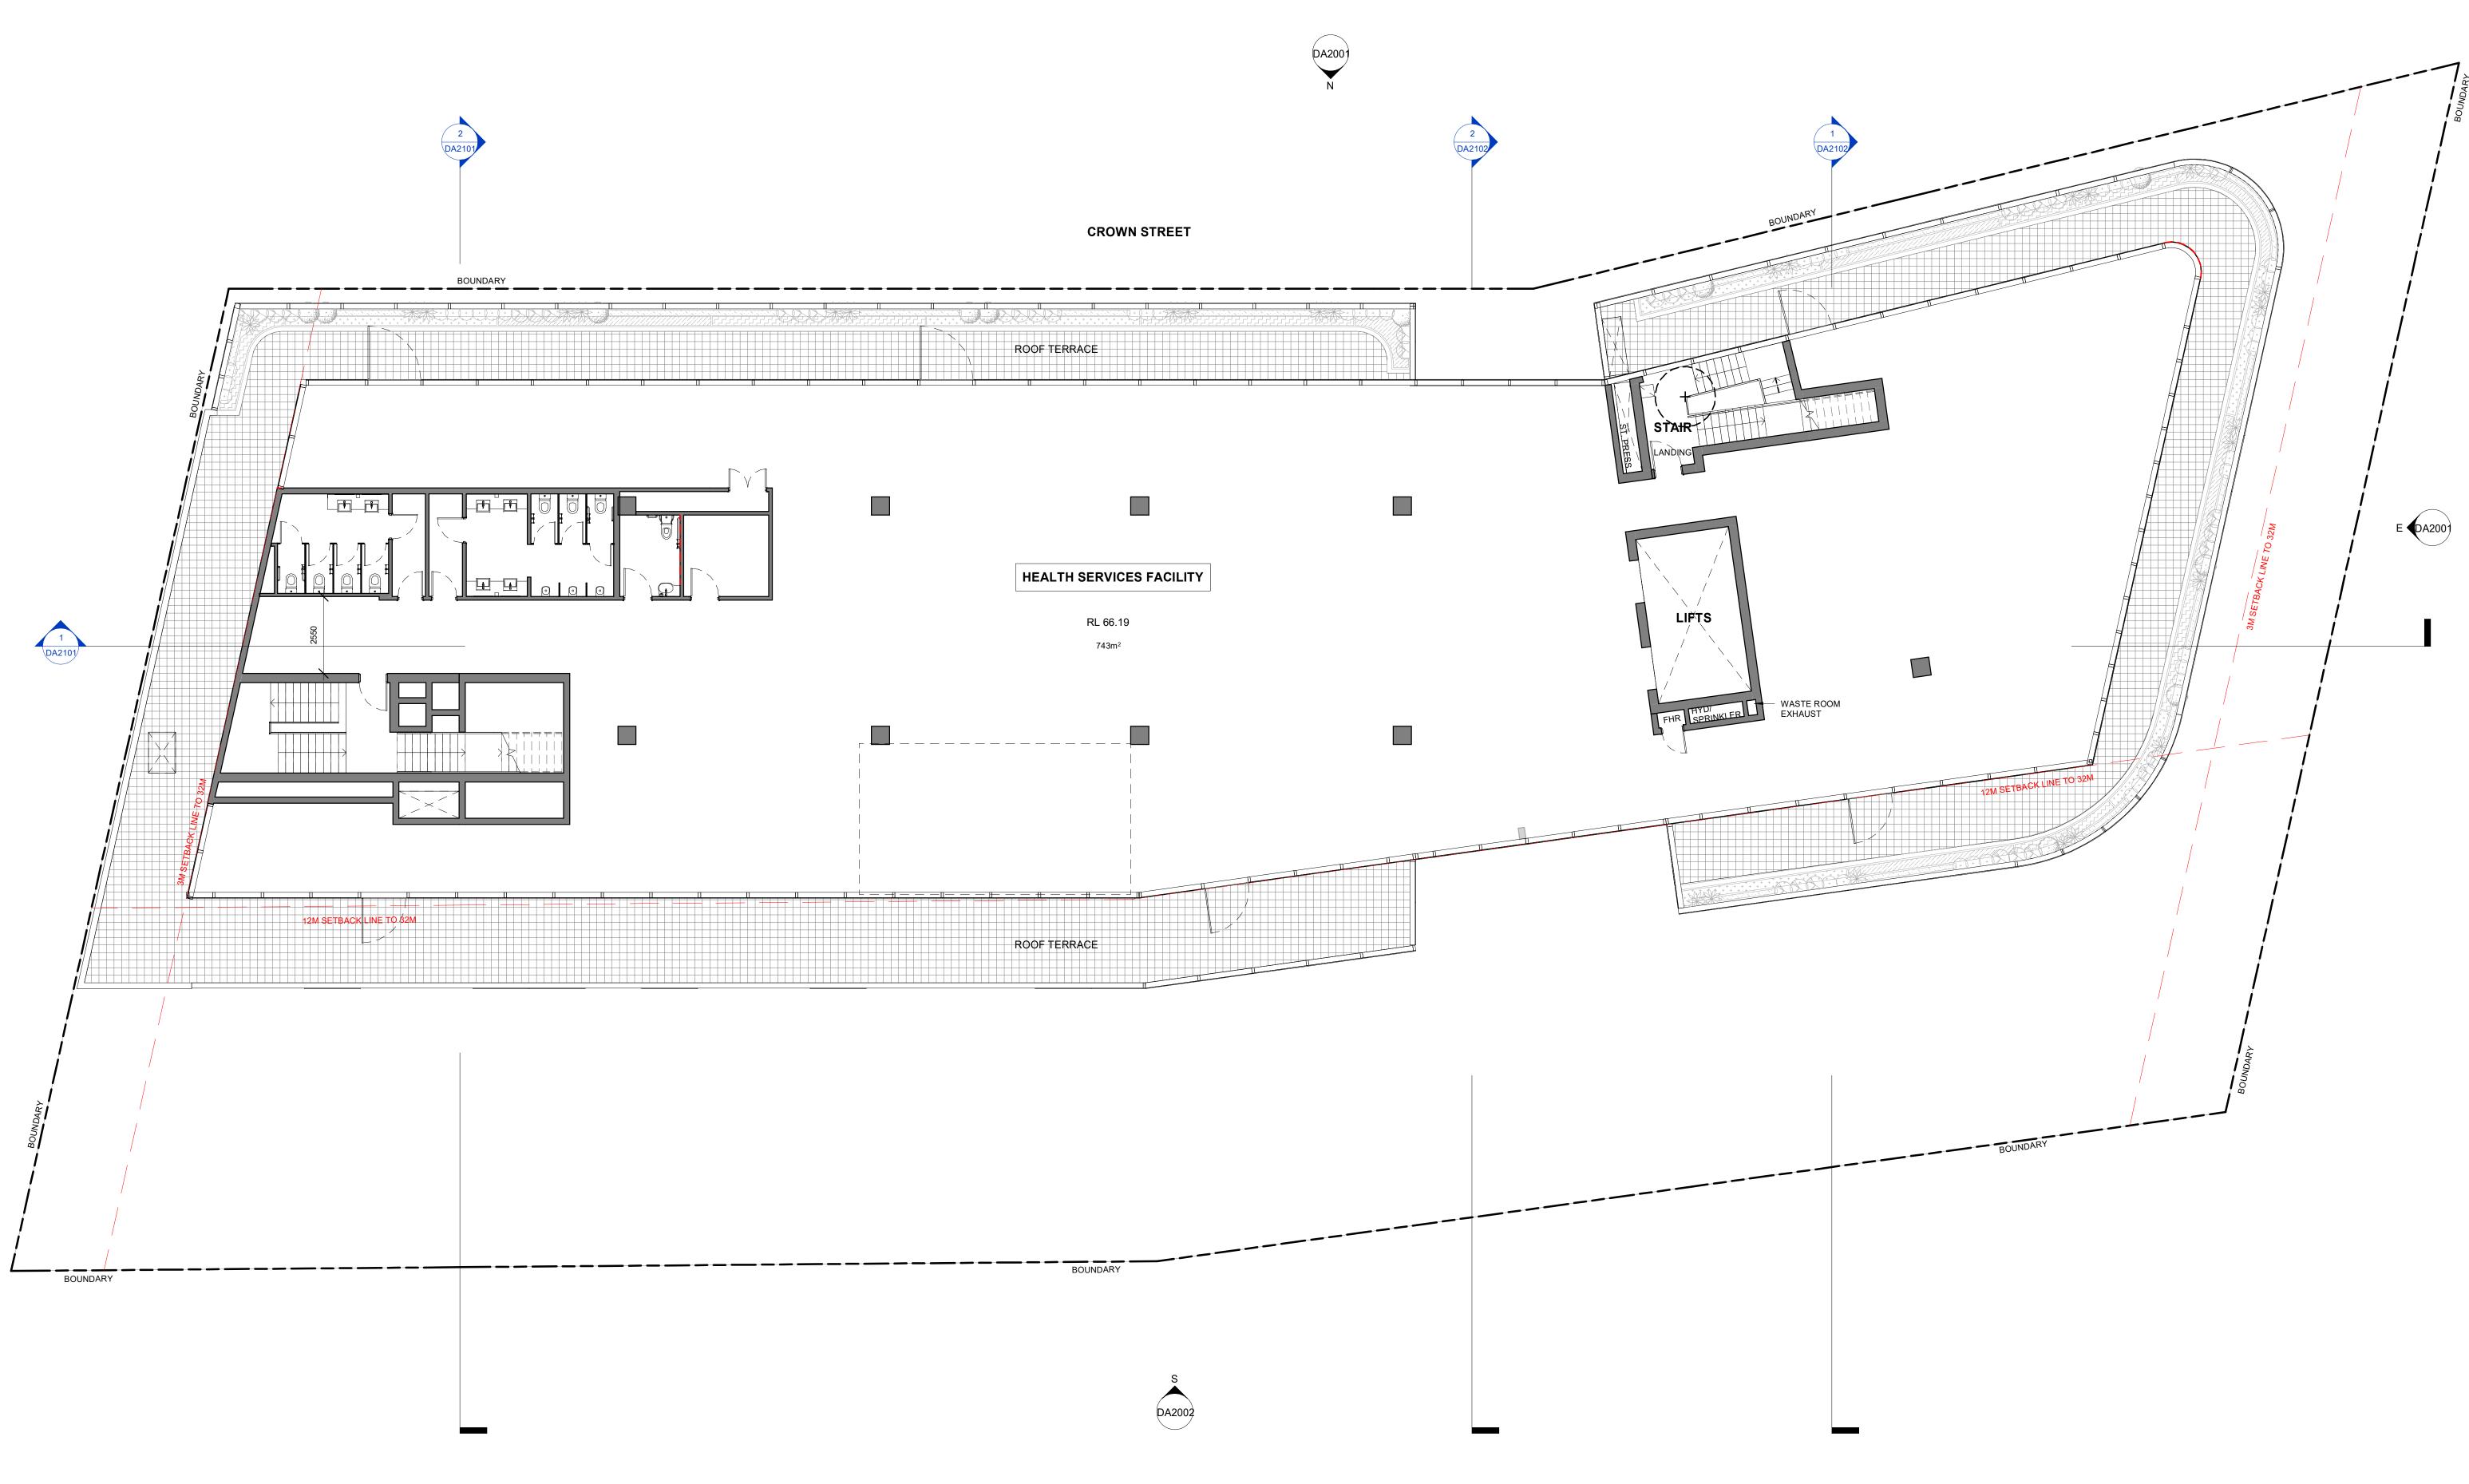
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PROJECT TITLE Proposed Medical Facility 411-417 Crown Street, Wollongong

CLIENT
Coveston Developments Pty Ltd

DRAWING TITLE Level 4

LEGEND



1 Level 5
1: 100

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PROJECT TITLE


Proposed Medical Facility 411-417 Crown Street, Wollongong

CLIENT
Coveston Developments Pty Ltd

DRAWING TITLE Level 5

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LEGEND

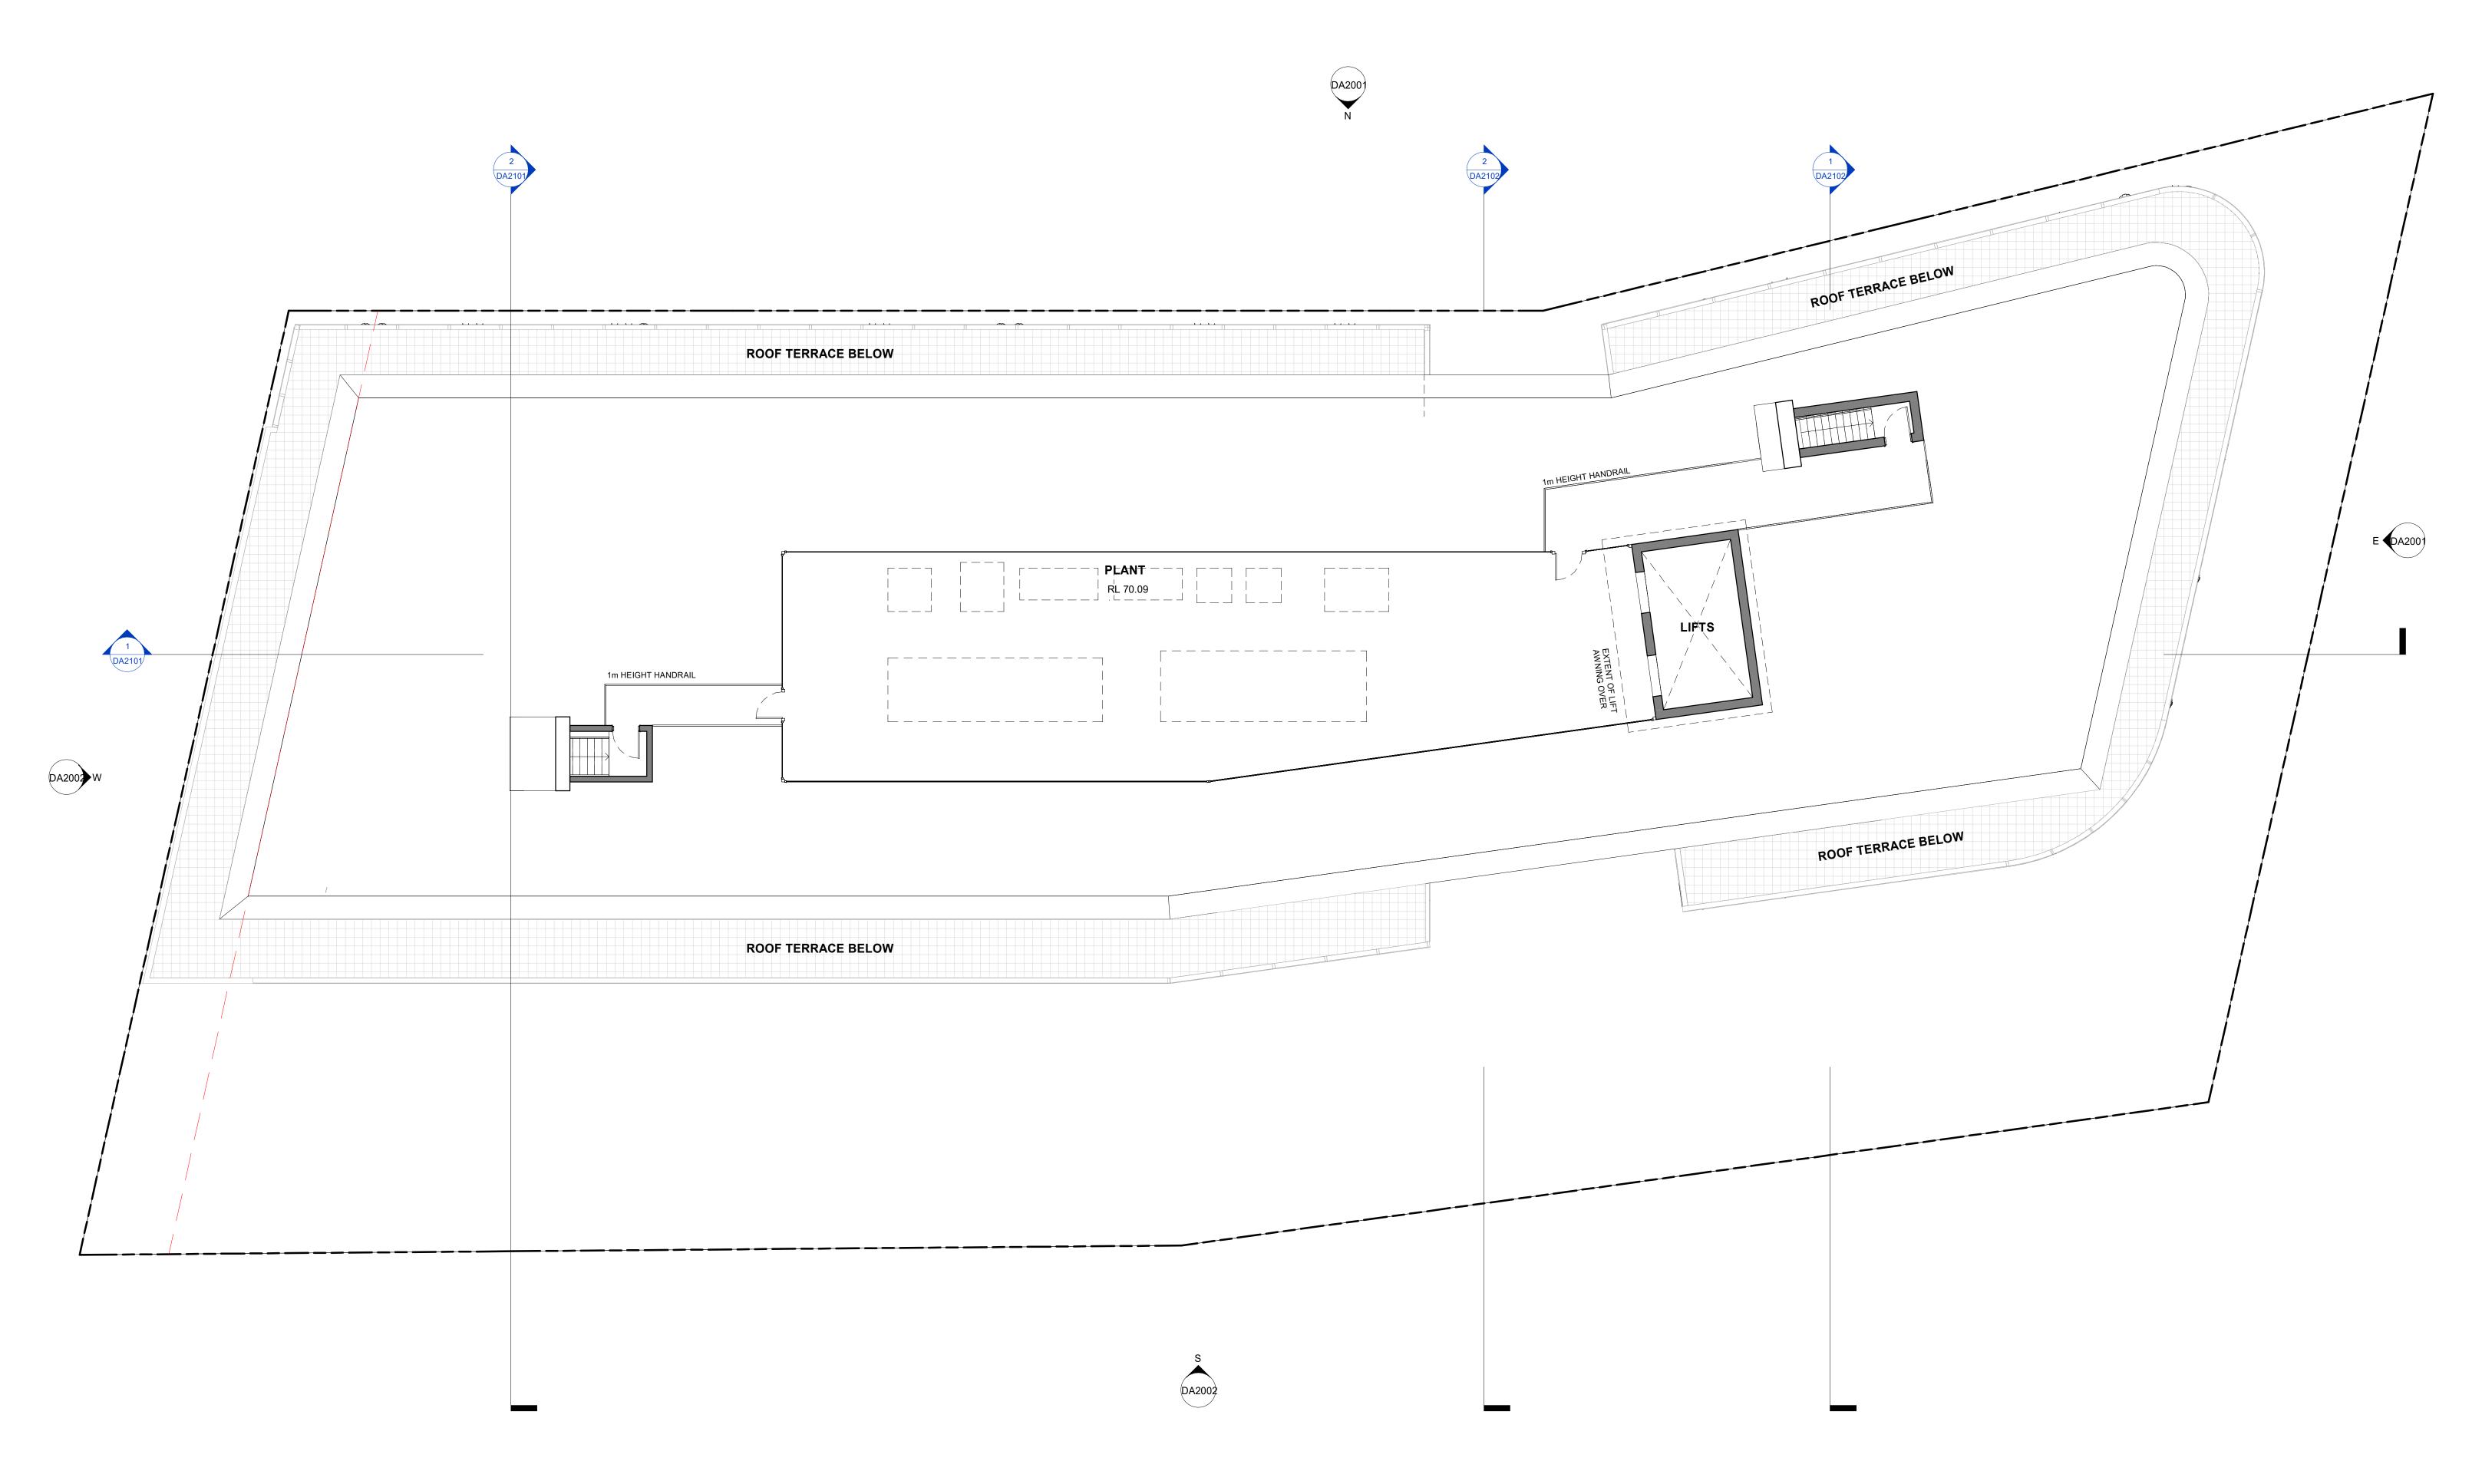

DA - Level 6 Floor Plan
1: 100

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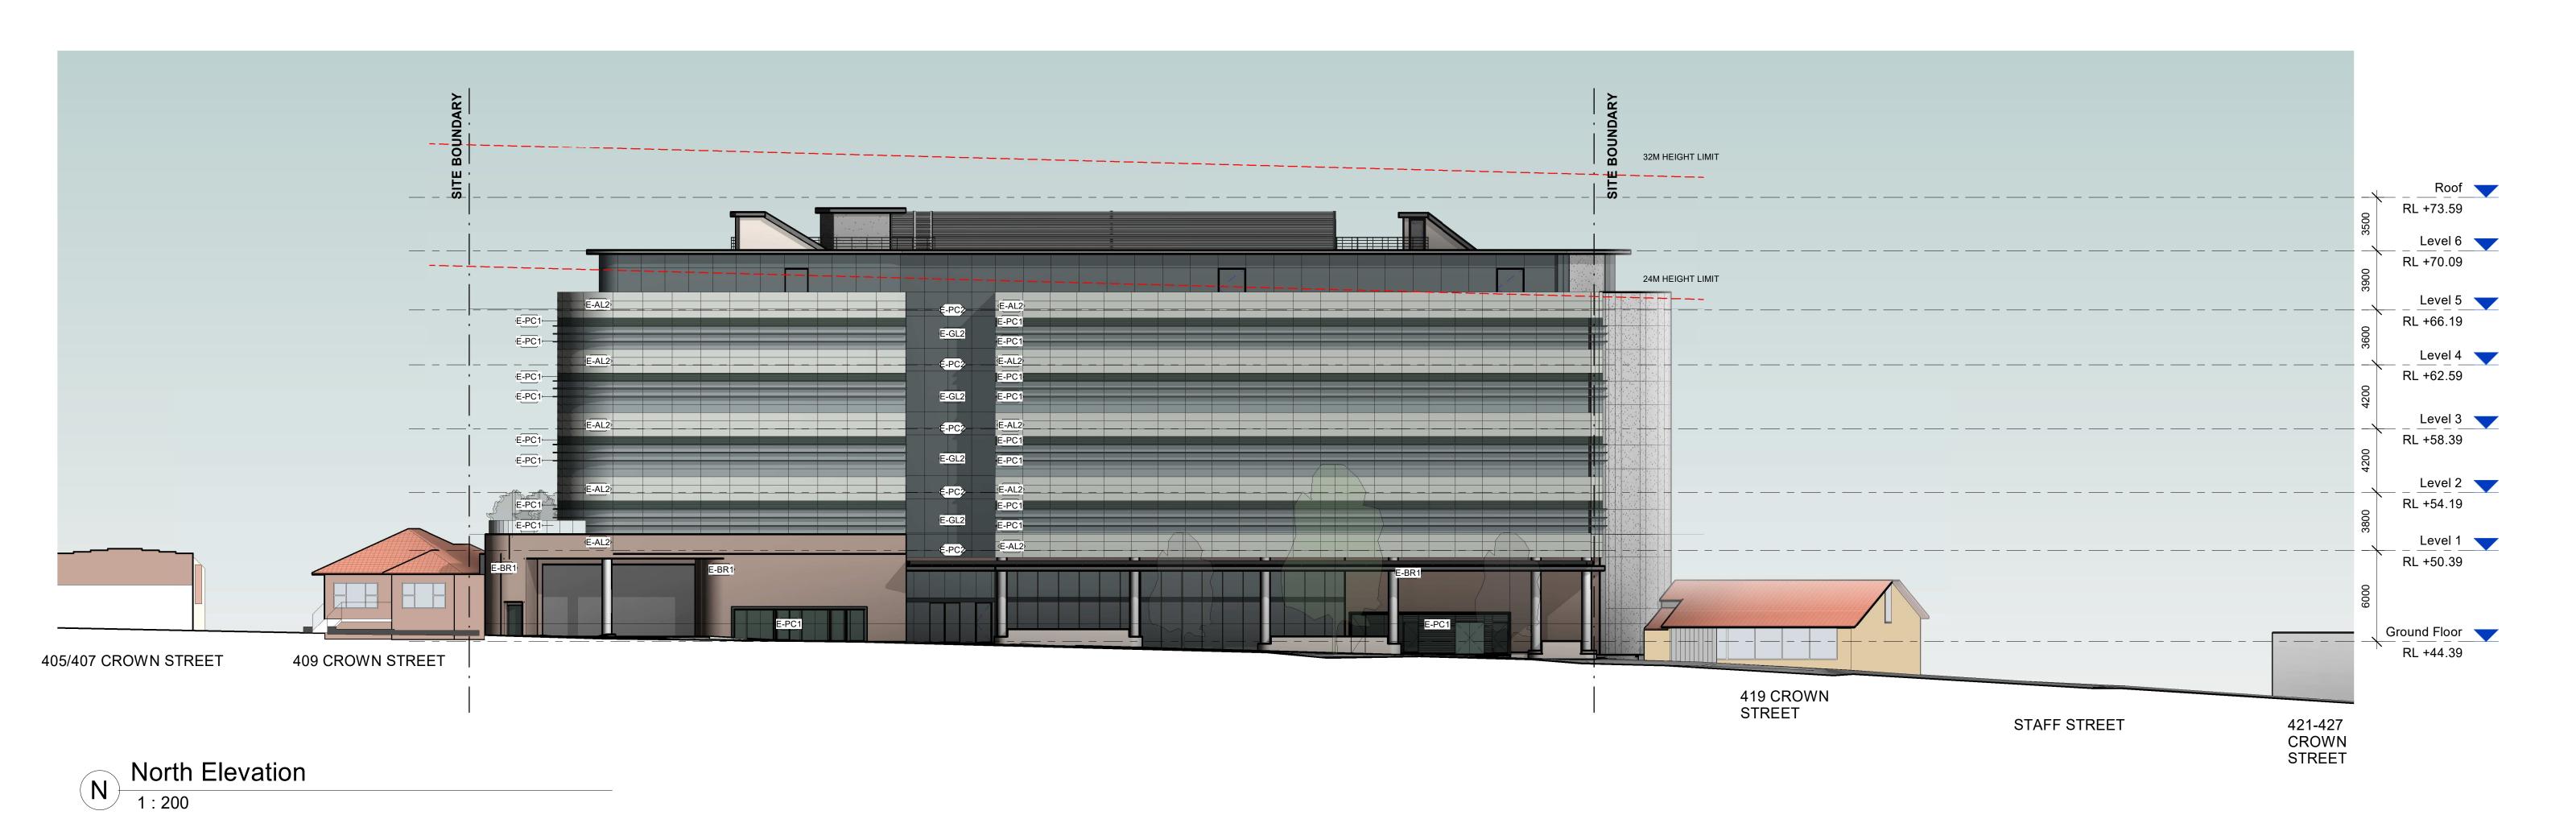
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PROJECT TITLE Proposed Medical Facility 411-417 Crown Street, Wollongong

CLIENT
Coveston Developments Pty Ltd

DRAWING TITLE Level 6

SCALE @ B1 1:100 DATE MAY 2020



32M HE GHT LIMIT Roof RL +73.59 Level 6 RL +70.09 24M HEIGHT LIMIT Level 5 RL +66.19 Level 4 RL +62.59 Level 3 RL +58.39 Level 2 RL +54.19 Level 1 RL +50.39 Ground Floor RL +44.39 Basement 1 RL +41.09 (409 CROWN STREET) WOLLONGONG **CROWN STREET** PRIVATE HOSPITAL 28 STAFF STREET STAFF STREET

E East Elevation

1:200

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LEGEND

LEGEND					
External Finishes Schedule					
Image	Mark	Description			
	E-AL2	Ultracore Papyrus White panel or similar			
	E-BR1	Bowral50 Brick or similar Colour: Simmental Silver			
	E-CONC	Pre Cast Concrete			
	E-GL	Grey Glass			
	E-GL2	Dark Grey Glass			
	E-PC1	Interpon D3020 Fluoromax Sea Storm Matt or similar			
	E-PC2	Interpon D2525 Futura Dark Grey Matt or similar			

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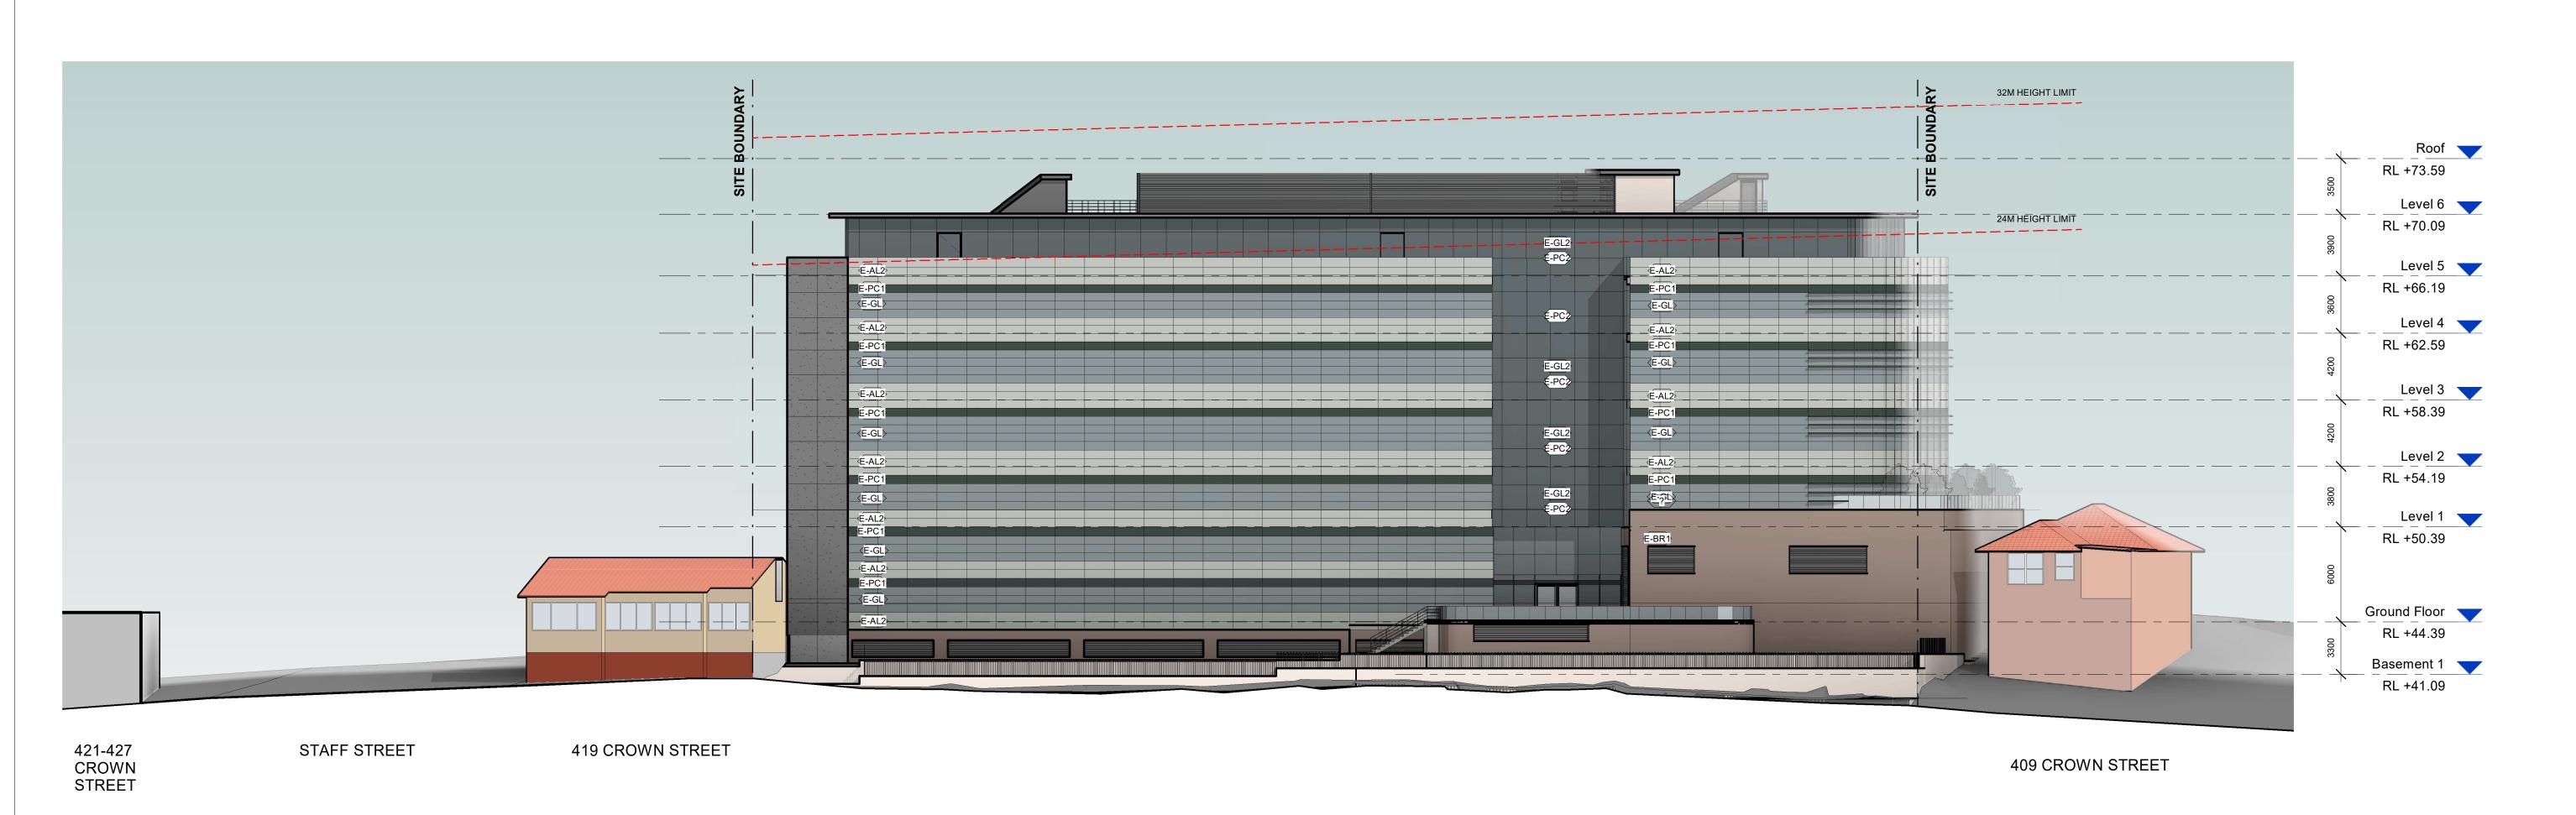
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PROJECT TITLE Proposed Medical Facility 411-417 Crown Street, Wollongong


CLIENT
Coveston Developments Pty Ltd

DRAWING TITLE Elevations - North and East

SCALE @ B1 1:200



South Elevation
1:200

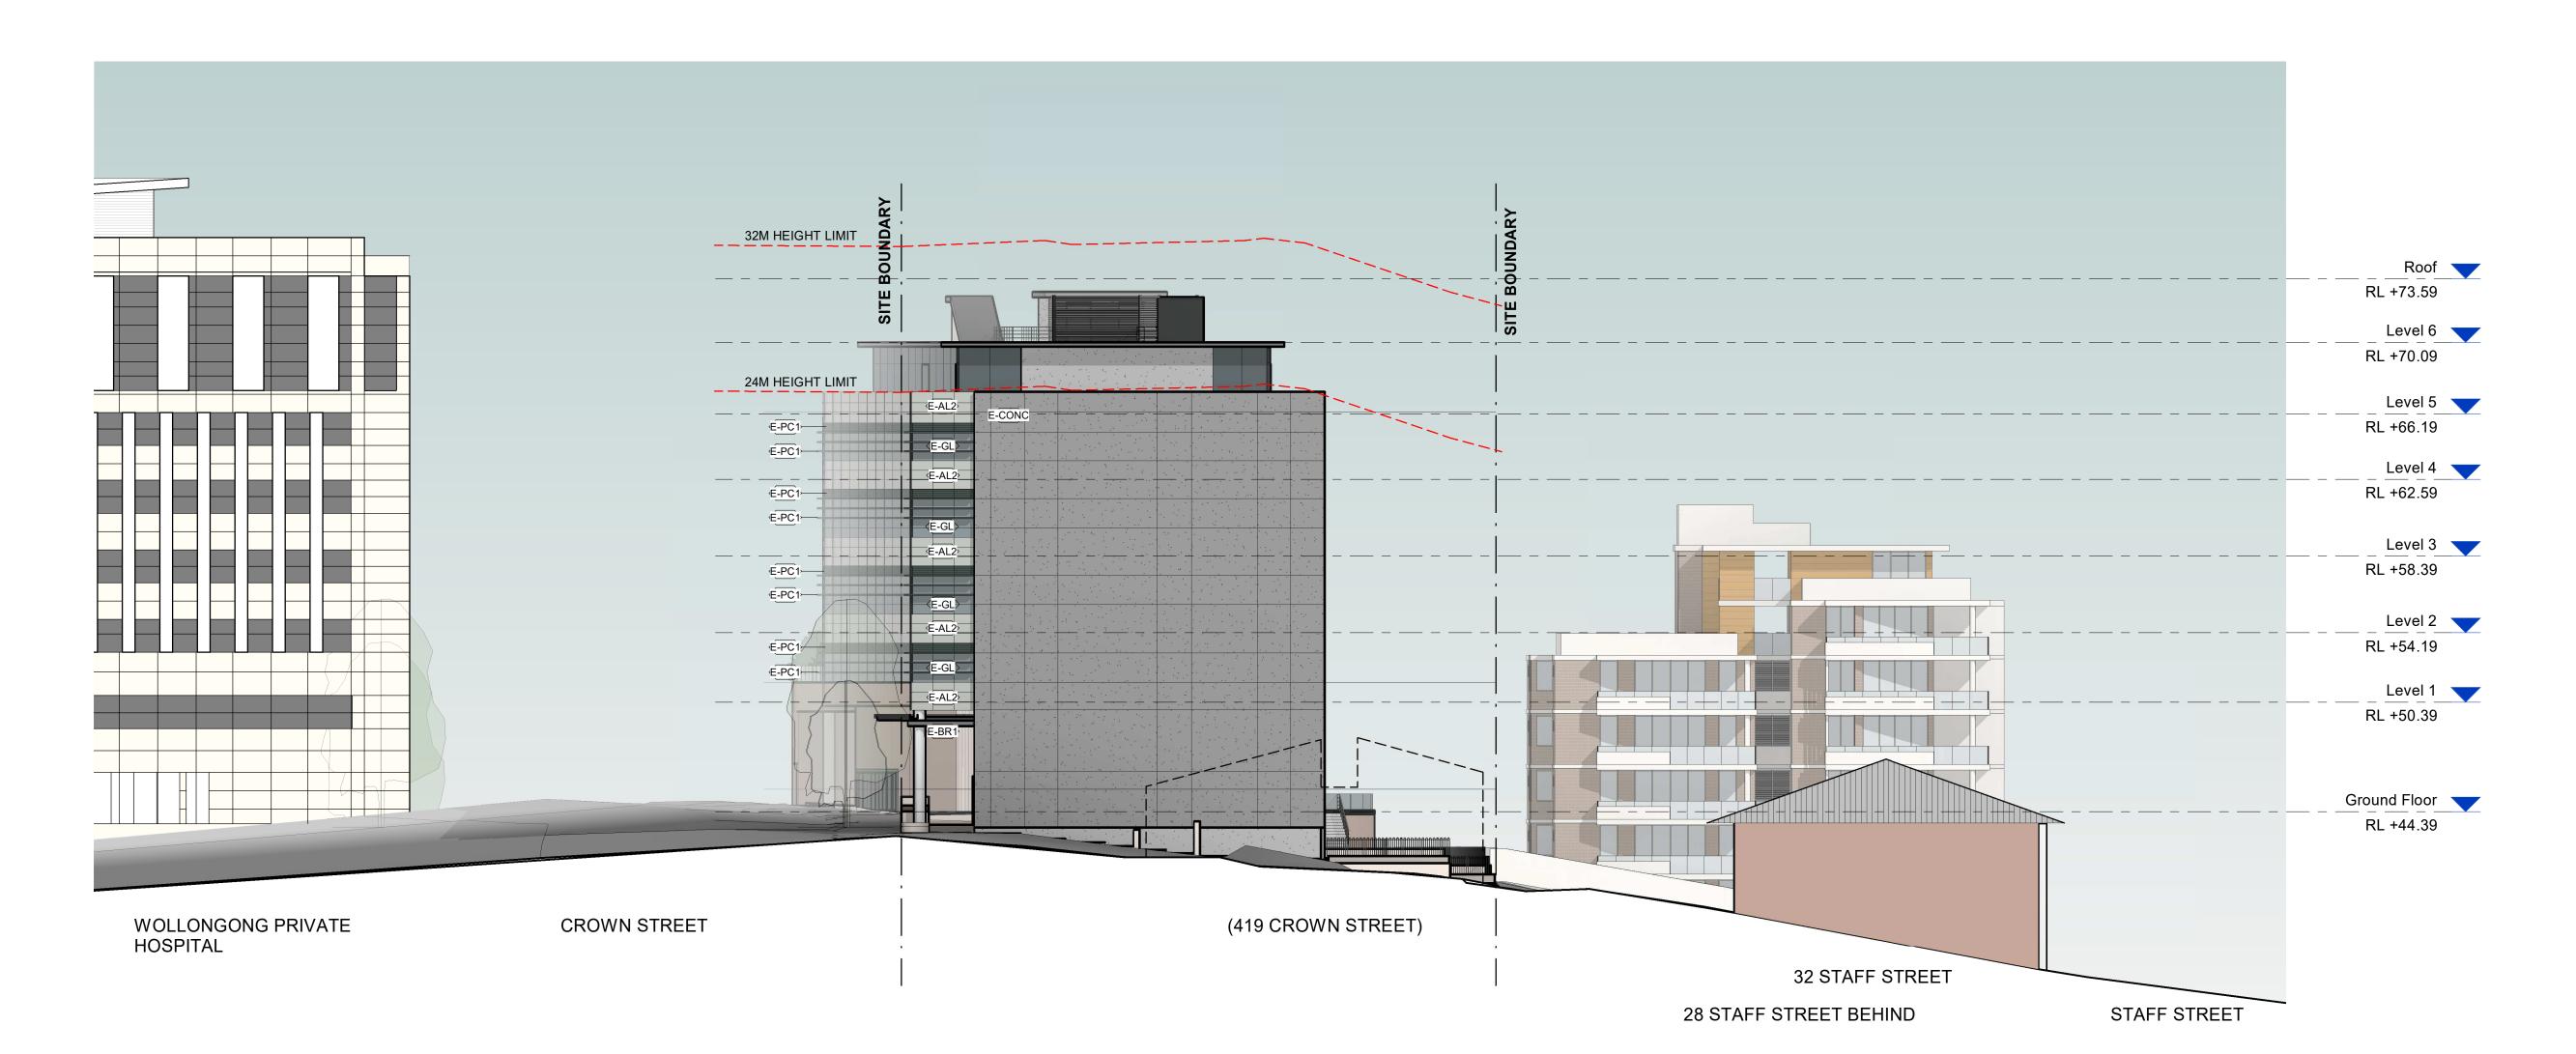

West Elevation
1:200

LEGEND External Finishes Schedule Mark Description Image Ultracore Papyrus E-AL2 White panel or similar Bowral50 Brick or Colour: Simmental E-CONC Pre Cast Concrete E-GL Grey Glass E-GL2 Dark Grey Glass Interpon D3020 Fluoromax Sea Storm Matt or similar Interpon D2525 Futura Dark Grey Matt or similar

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ACN 069 737 935

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ACN 069 737 935
NOMINATED ARCHITECT - ANTHONY VAVAYIS NO.5243

PROJECT TITLE

Proposed Medical Facility

Proposed Medical Facility
411-417 Crown Street, Wollongong

CLIENT
Coveston Developments Pty Ltd

DRAWING TITLE
Elevations - South and West

CALE @ B1 1:200 DATE MAY 2020

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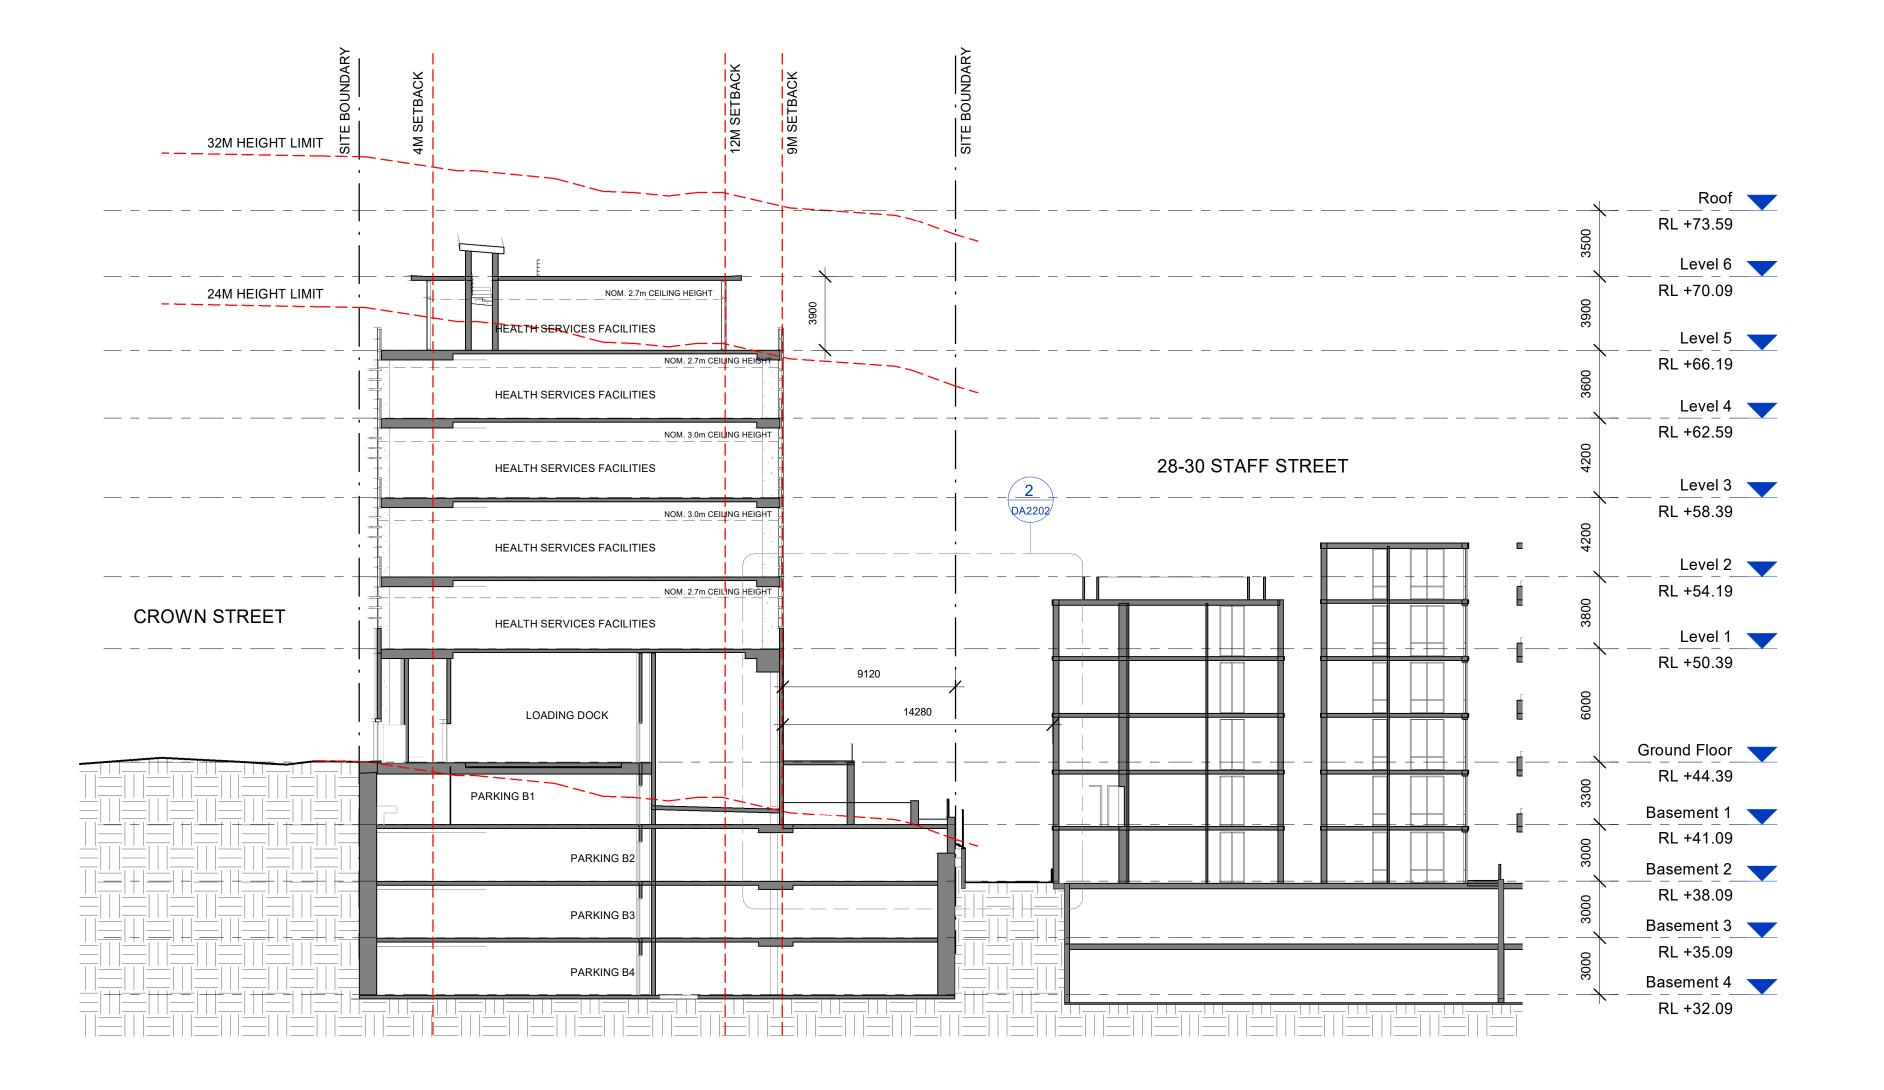
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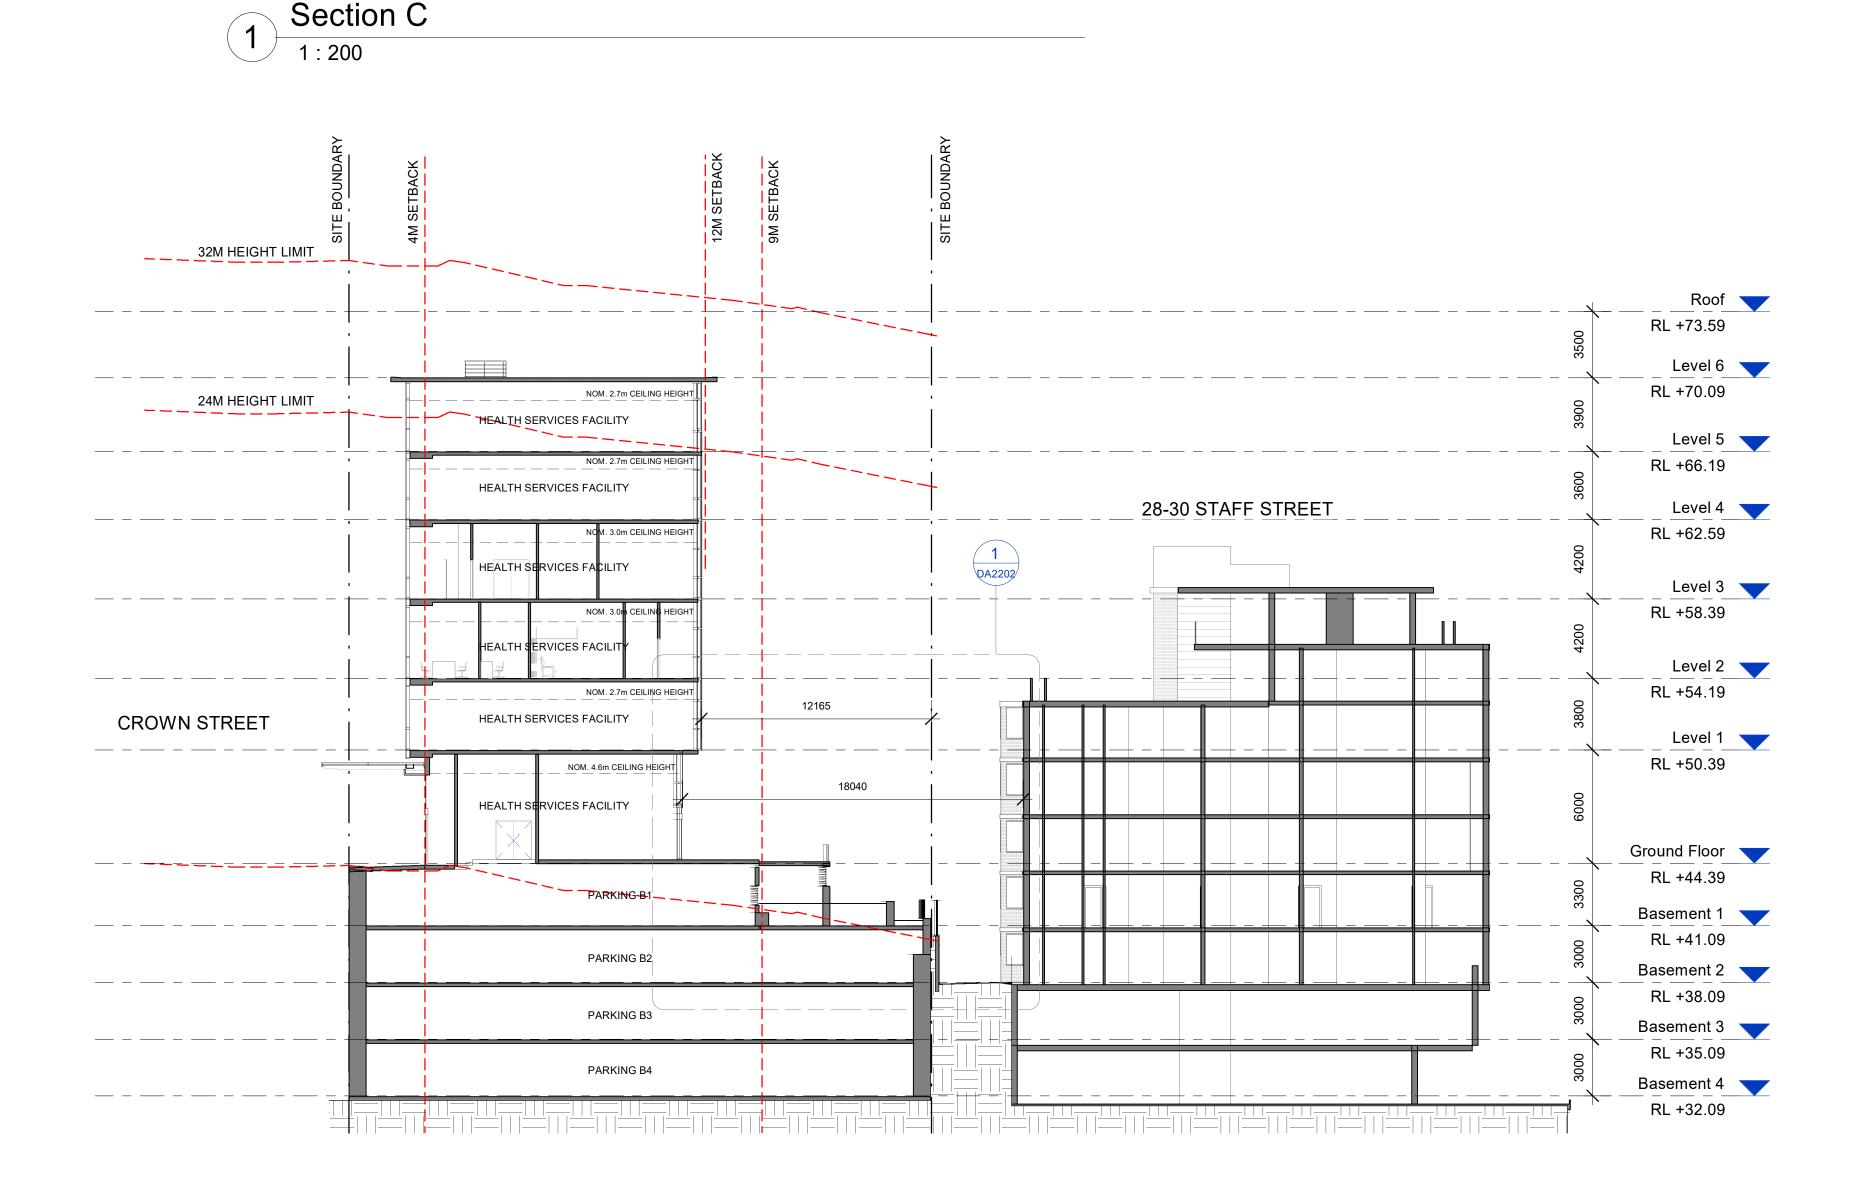
PROJECT TITLE Proposed Medical Facility 411-417 Crown Street, Wollongong


COVESTON Developments Pty Ltd

DRAWING TITLE Sections 1

SCALE @ B1 1:200 DATE MAY 2020





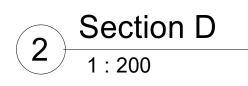

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ACN 069 737 935
NOMINATED ARCHITECT - ANTHONY VAVAYIS NO.5243


PROJECT TITLE
Proposed Medical Facility
411-417 Crown Street, Wollongong

CLIENT
Coveston Developments Pty Ltd

DRAWING TITLE
Sections 2

SCALE @ B1 1:200 DATE MAY 2020

DRAWN BY DL PROJECT 16011

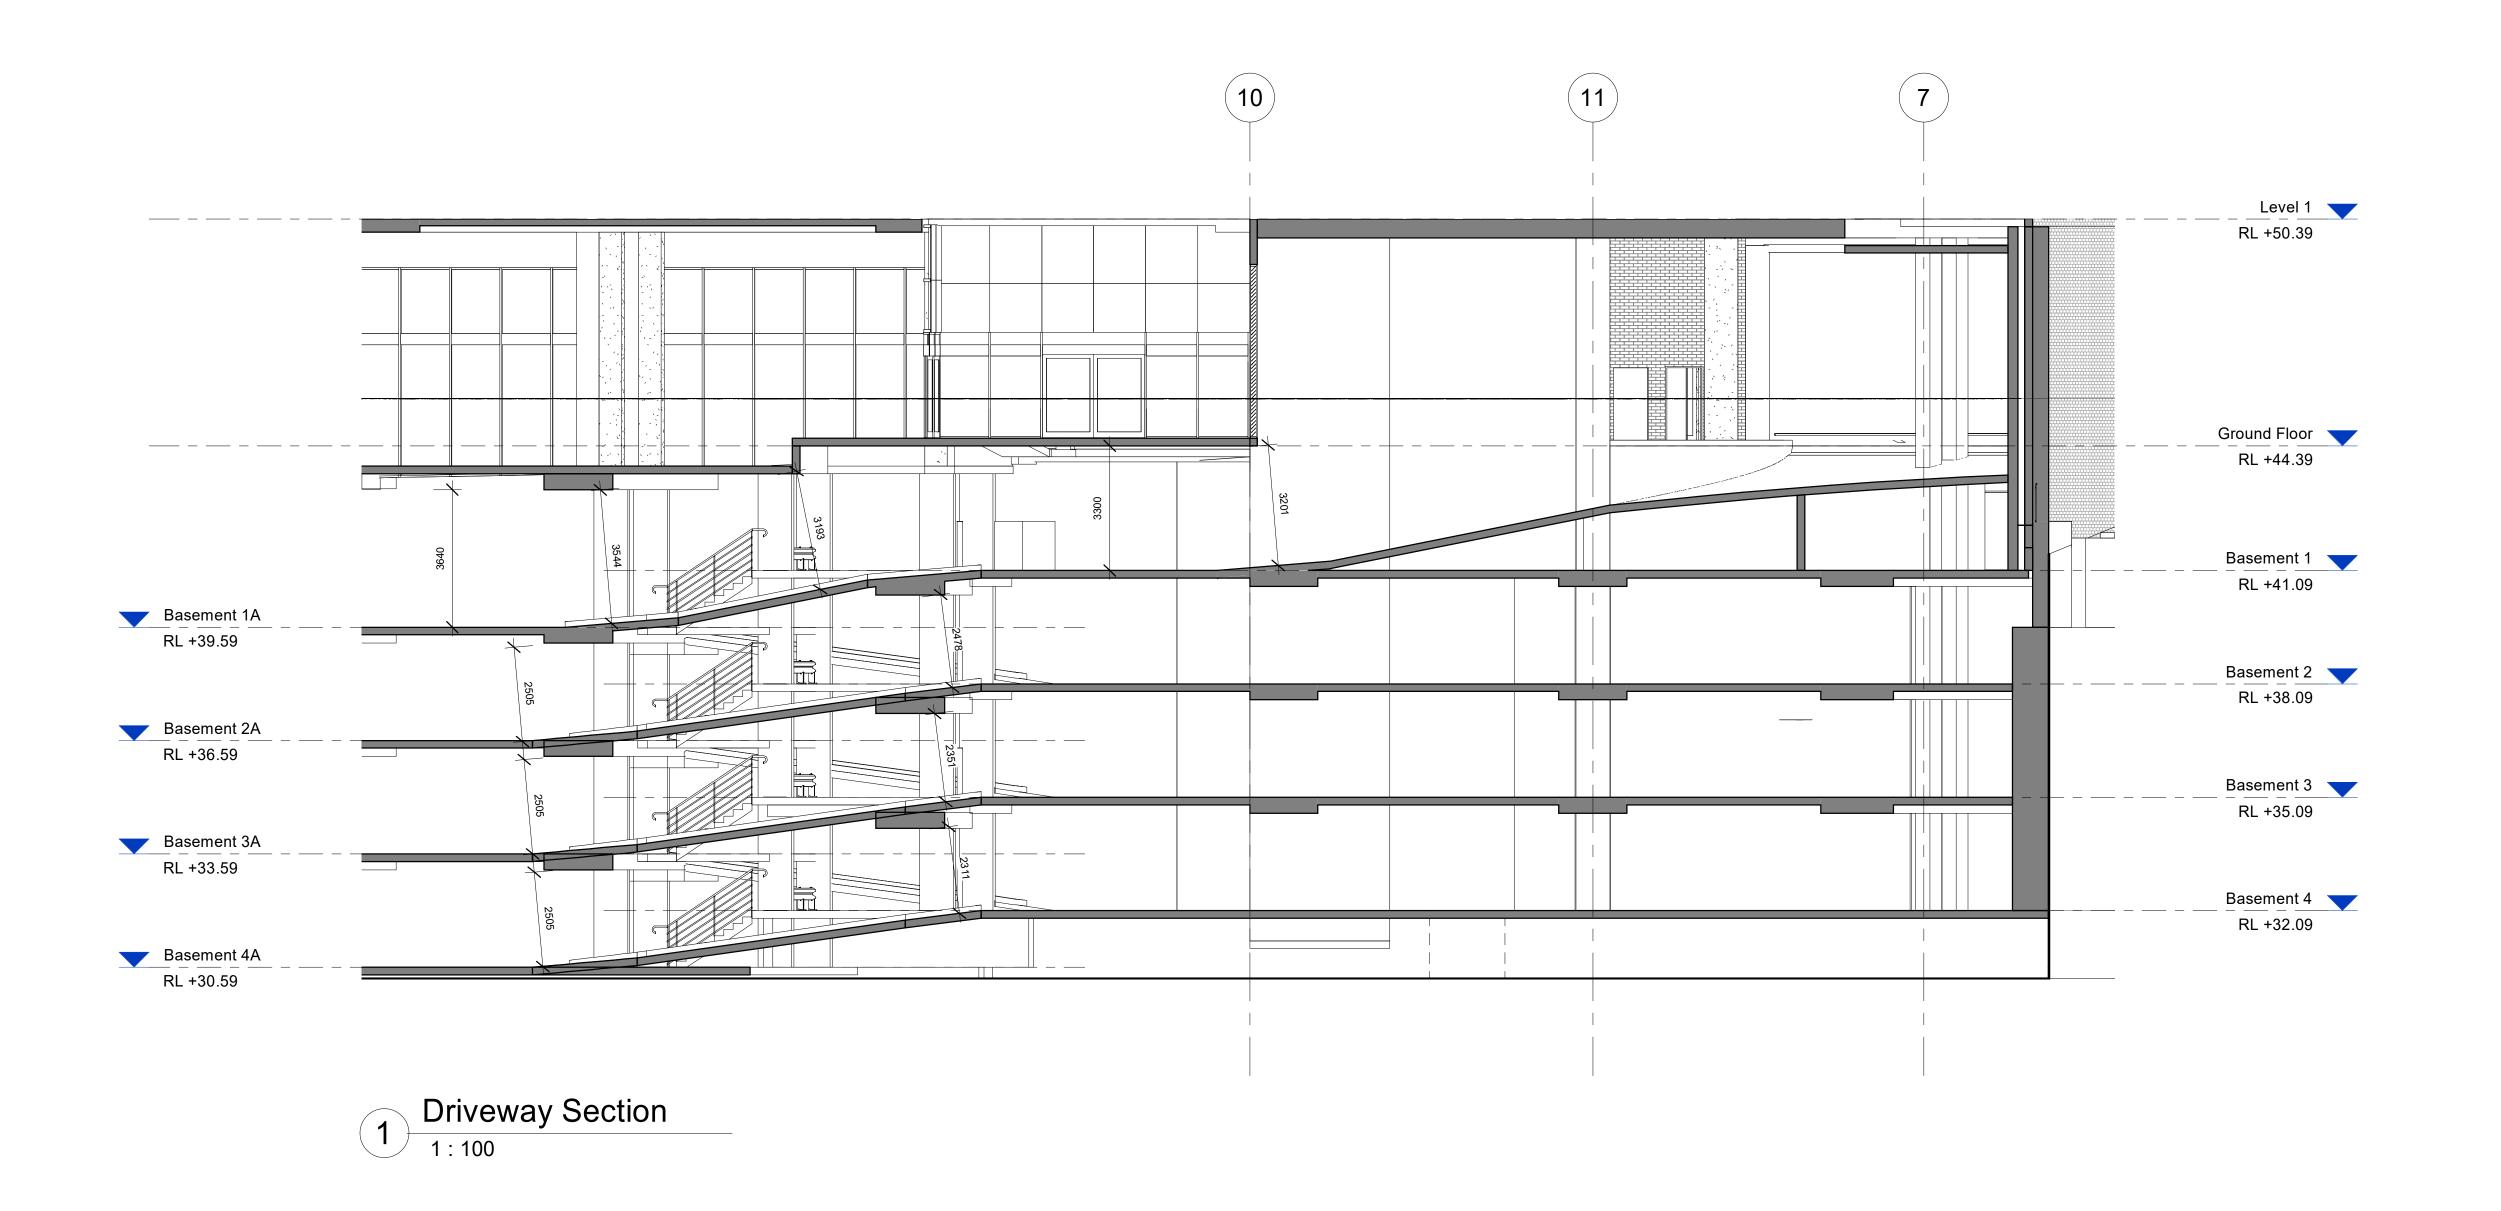

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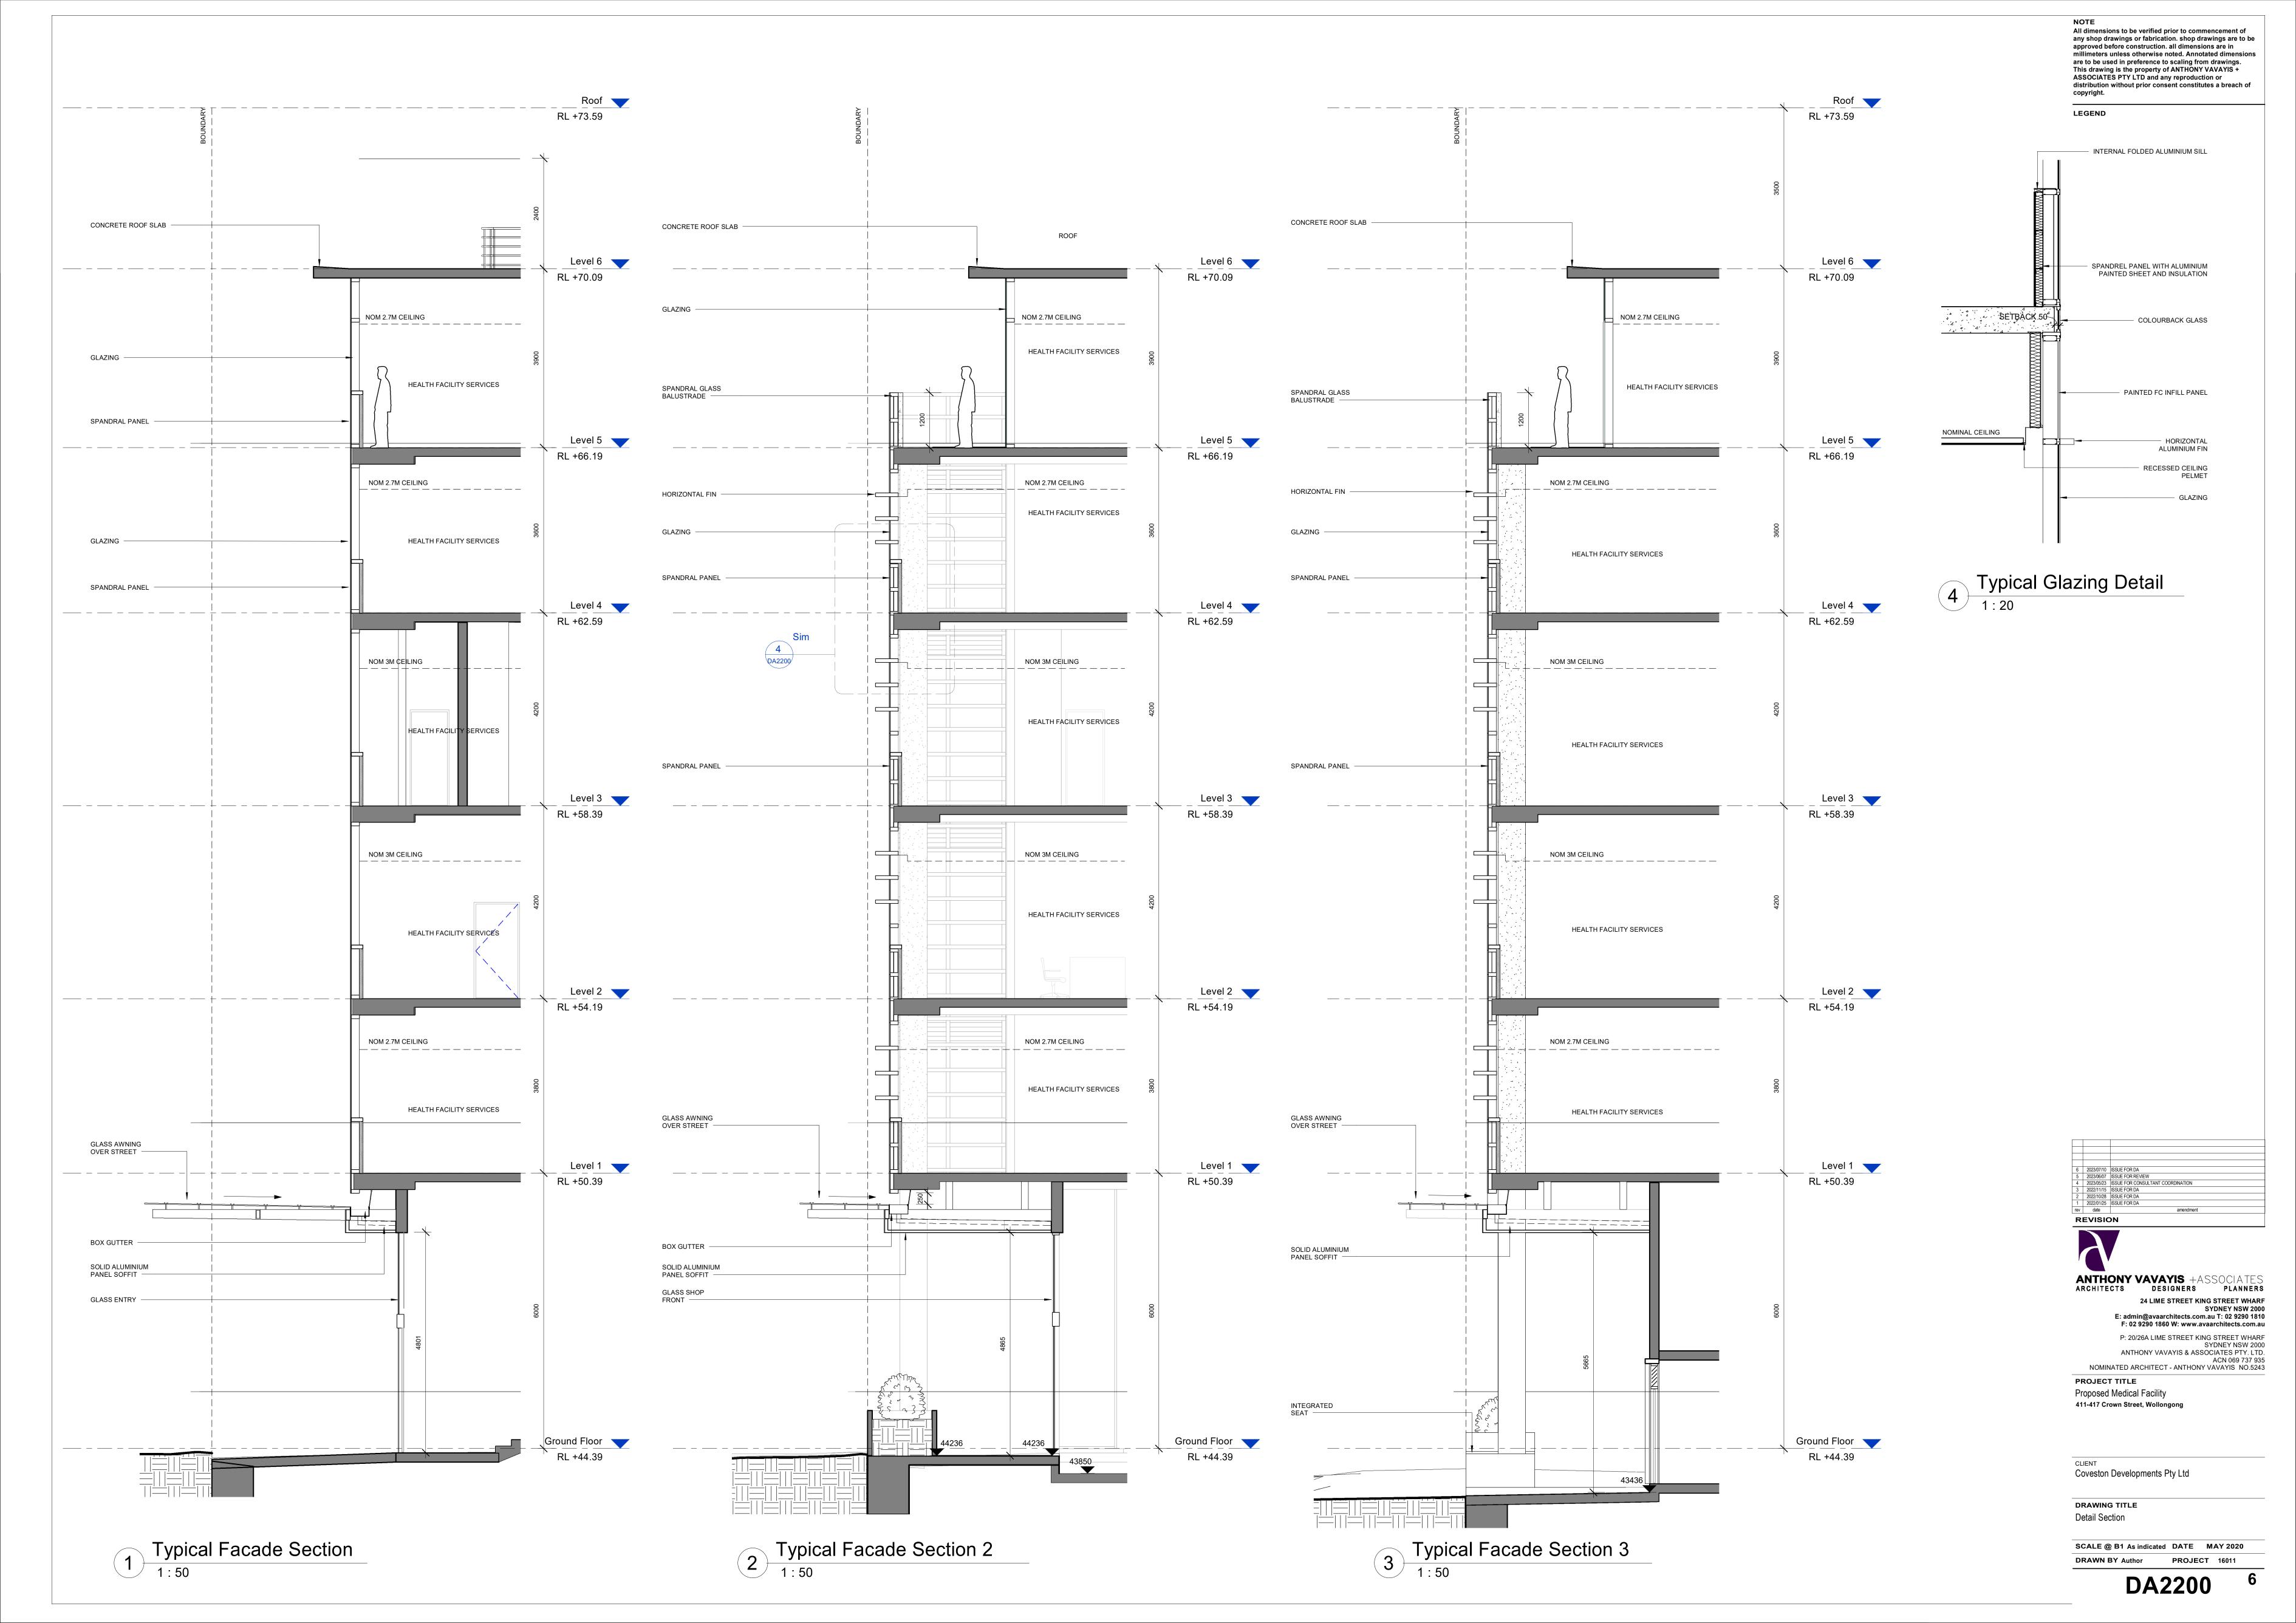
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PROJECT TITLE Proposed Medical Facility 411-417 Crown Street, Wollongong

CLIENT
Coveston Developments Pty Ltd

DRAWING TITLE Sections 3

SCALE @ B1 1:100 DATE MAY 2020



1 L1 Planter Detail

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PROJECT TITLE Proposed Medical Facility 411-417 Crown Street, Wollongong

CLIENT
Coveston Developments Pty Ltd


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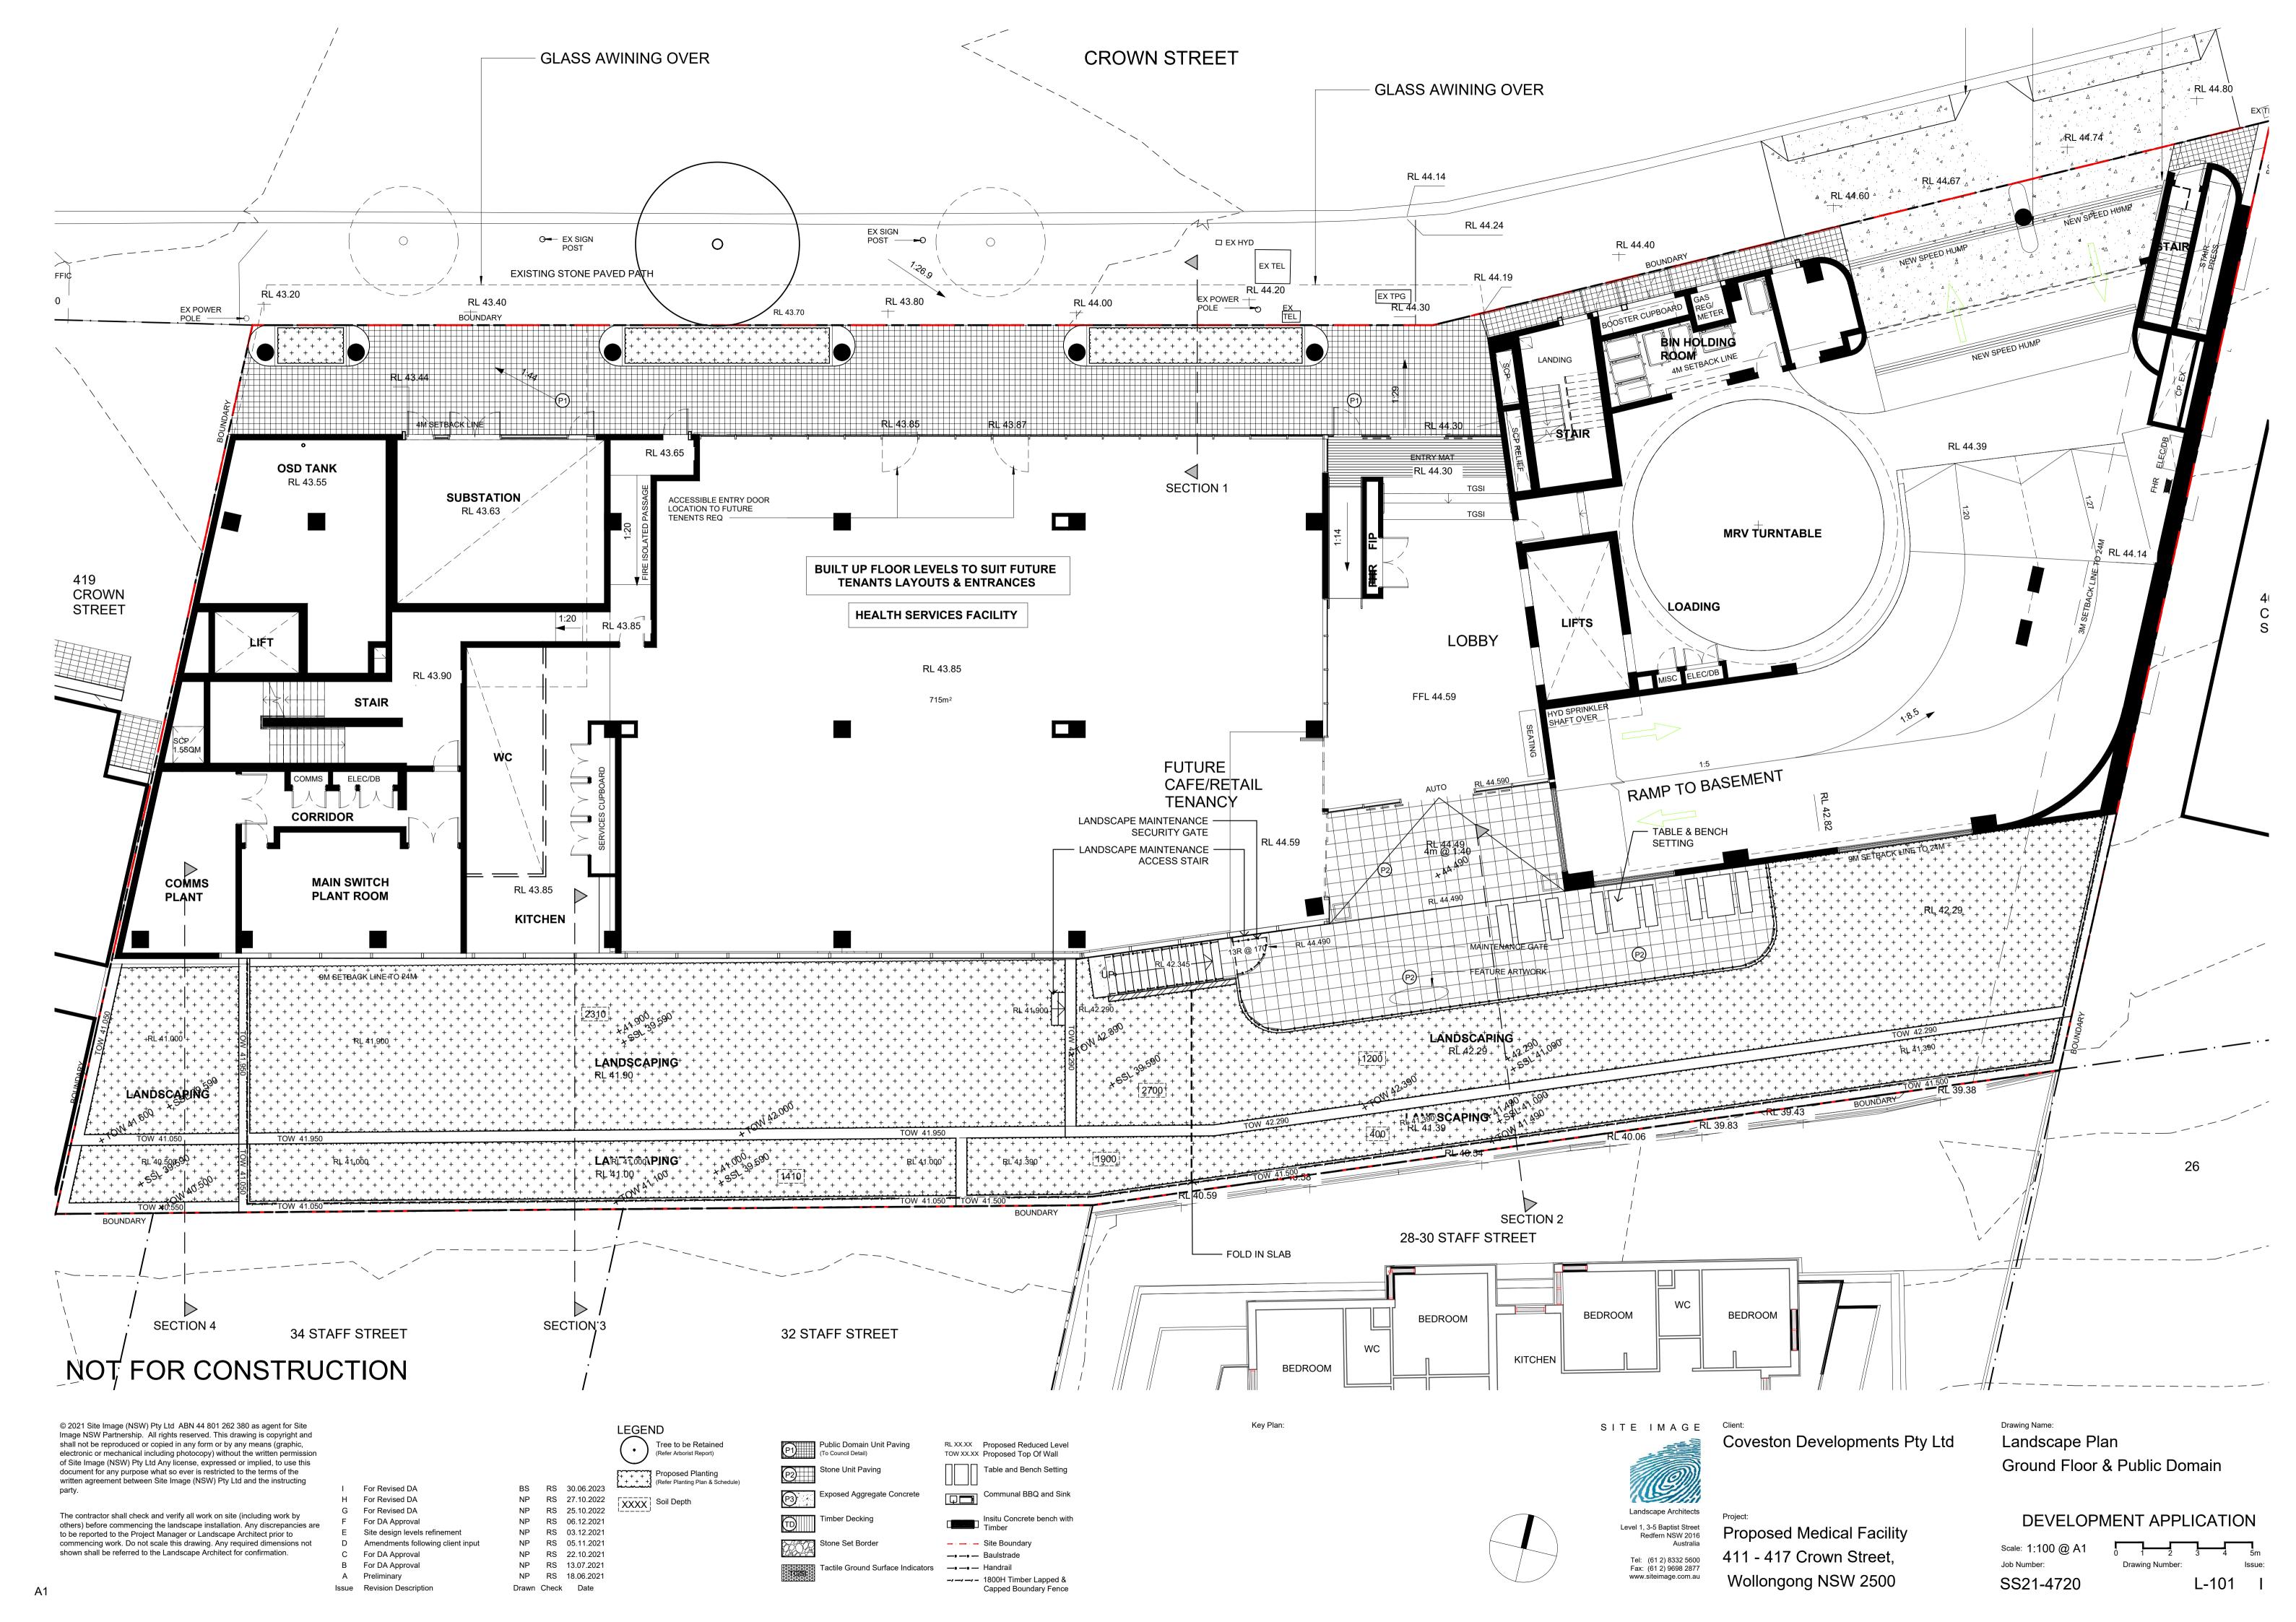
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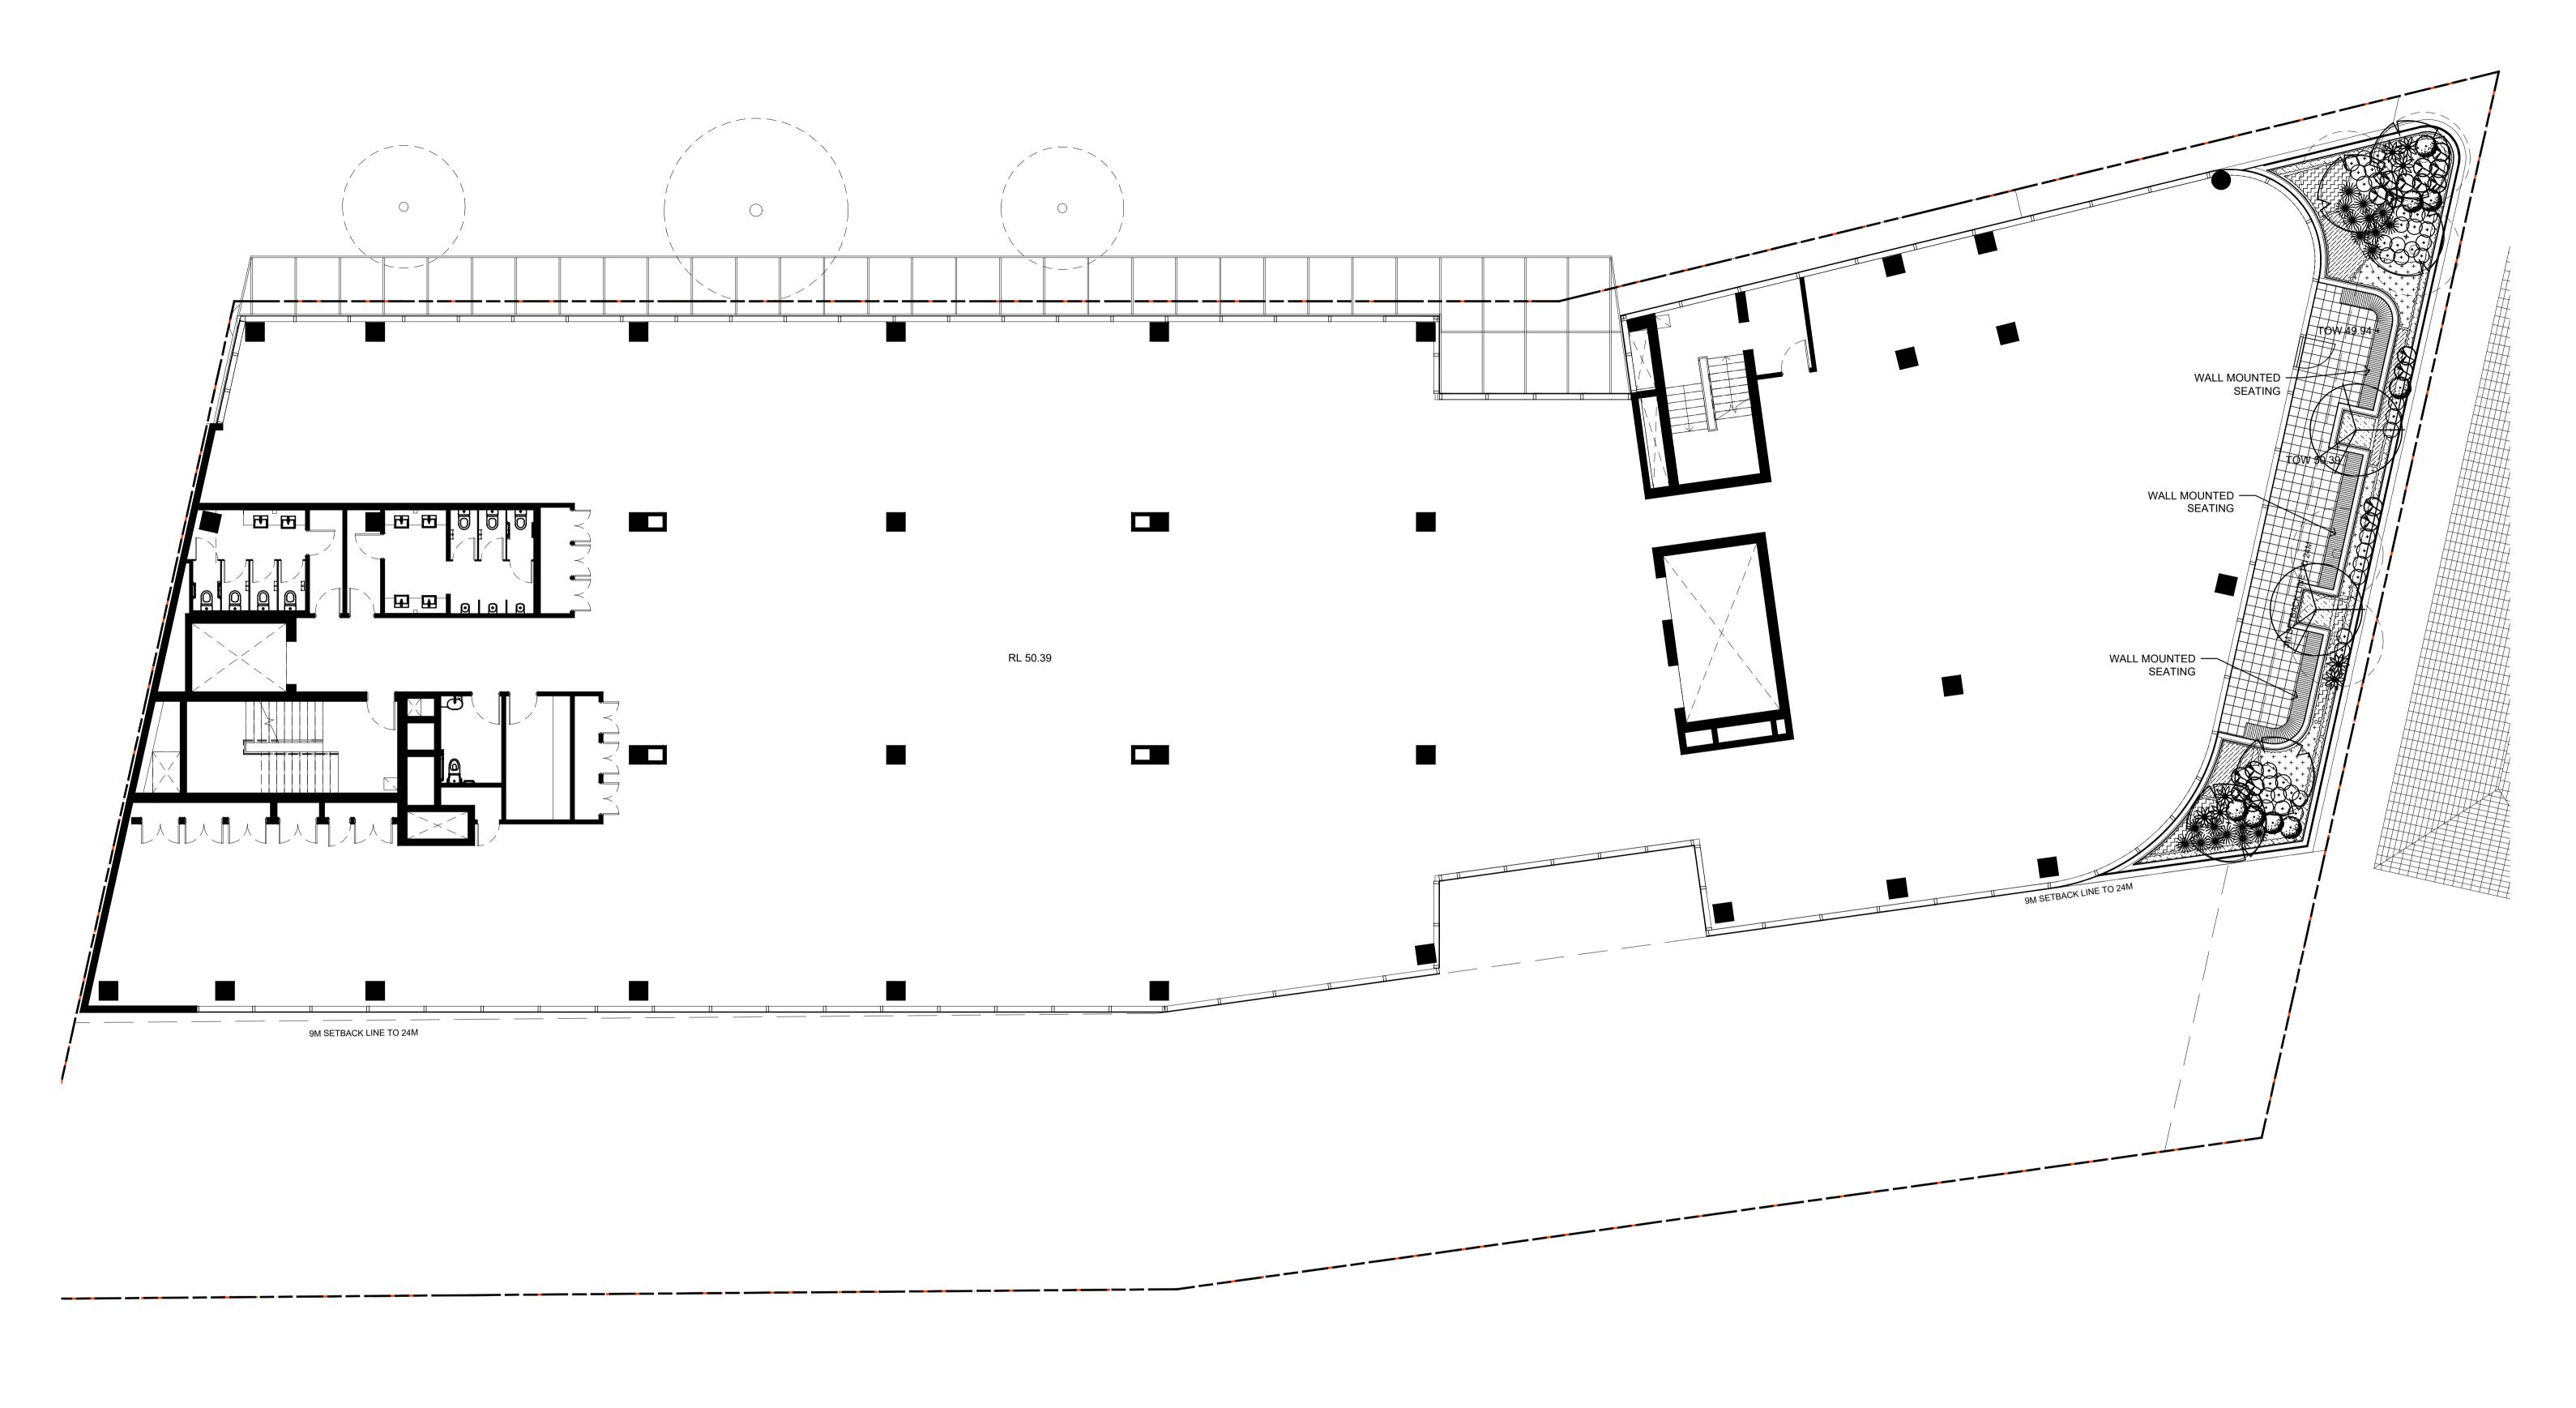
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PALISADE FENCE EXTERNAL BRICK LINING 4915 SUBFLOOR CARPARK BASEMENT 1 BASEMENT 1 PARKING RAMP SUBFLOOR Basement 1 RL +41.09 EXISTING
RETAINING WALL
AND FENCE ON
NEIGHBORNING EXISTING
RETAINING WALL
AND FENCE ON
NEIGHBOURING
PROPERTY CARPARK BASEMENT 2 CARPARK BASEMENT 2 38080 Basement 2 RL +38.09 3 2023/07/10 ISSUE FOR DA
2 2023/06/22 ISSUE FOR REVIEW
1 2023/06/07 ISSUE FOR REVIEW
rev date REVISION ANTHONY VAVAYIS +ASSOCIATES ARCHITECTS DESIGNERS PLANNERS 24 LIME STREET KING STREET WHARF SYDNEY NSW 2000 E: admin@avaarchitects.com.au T: 02 9290 1810 F: 02 9290 1860 W: www.avaarchitects.com.au 2 Typical Rear Boundary Section 2 Typical Rear Boundary Section

1:50 P: 20/26A LIME STREET KING STREET WHARF SYDNEY NSW 2000 ANTHONY VAVAYIS & ASSOCIATES PTY. LTD. ACN 069 737 935 NOMINATED ARCHITECT - ANTHONY VAVAYIS NO.5243 PROJECT TITLE Proposed Medical Facility 411-417 Crown Street, Wollongong CLIENT
Coveston Developments Pty Ltd DRAWING TITLE **Detail Section 3** SCALE @ B1 1:50 DATE MAY 2020





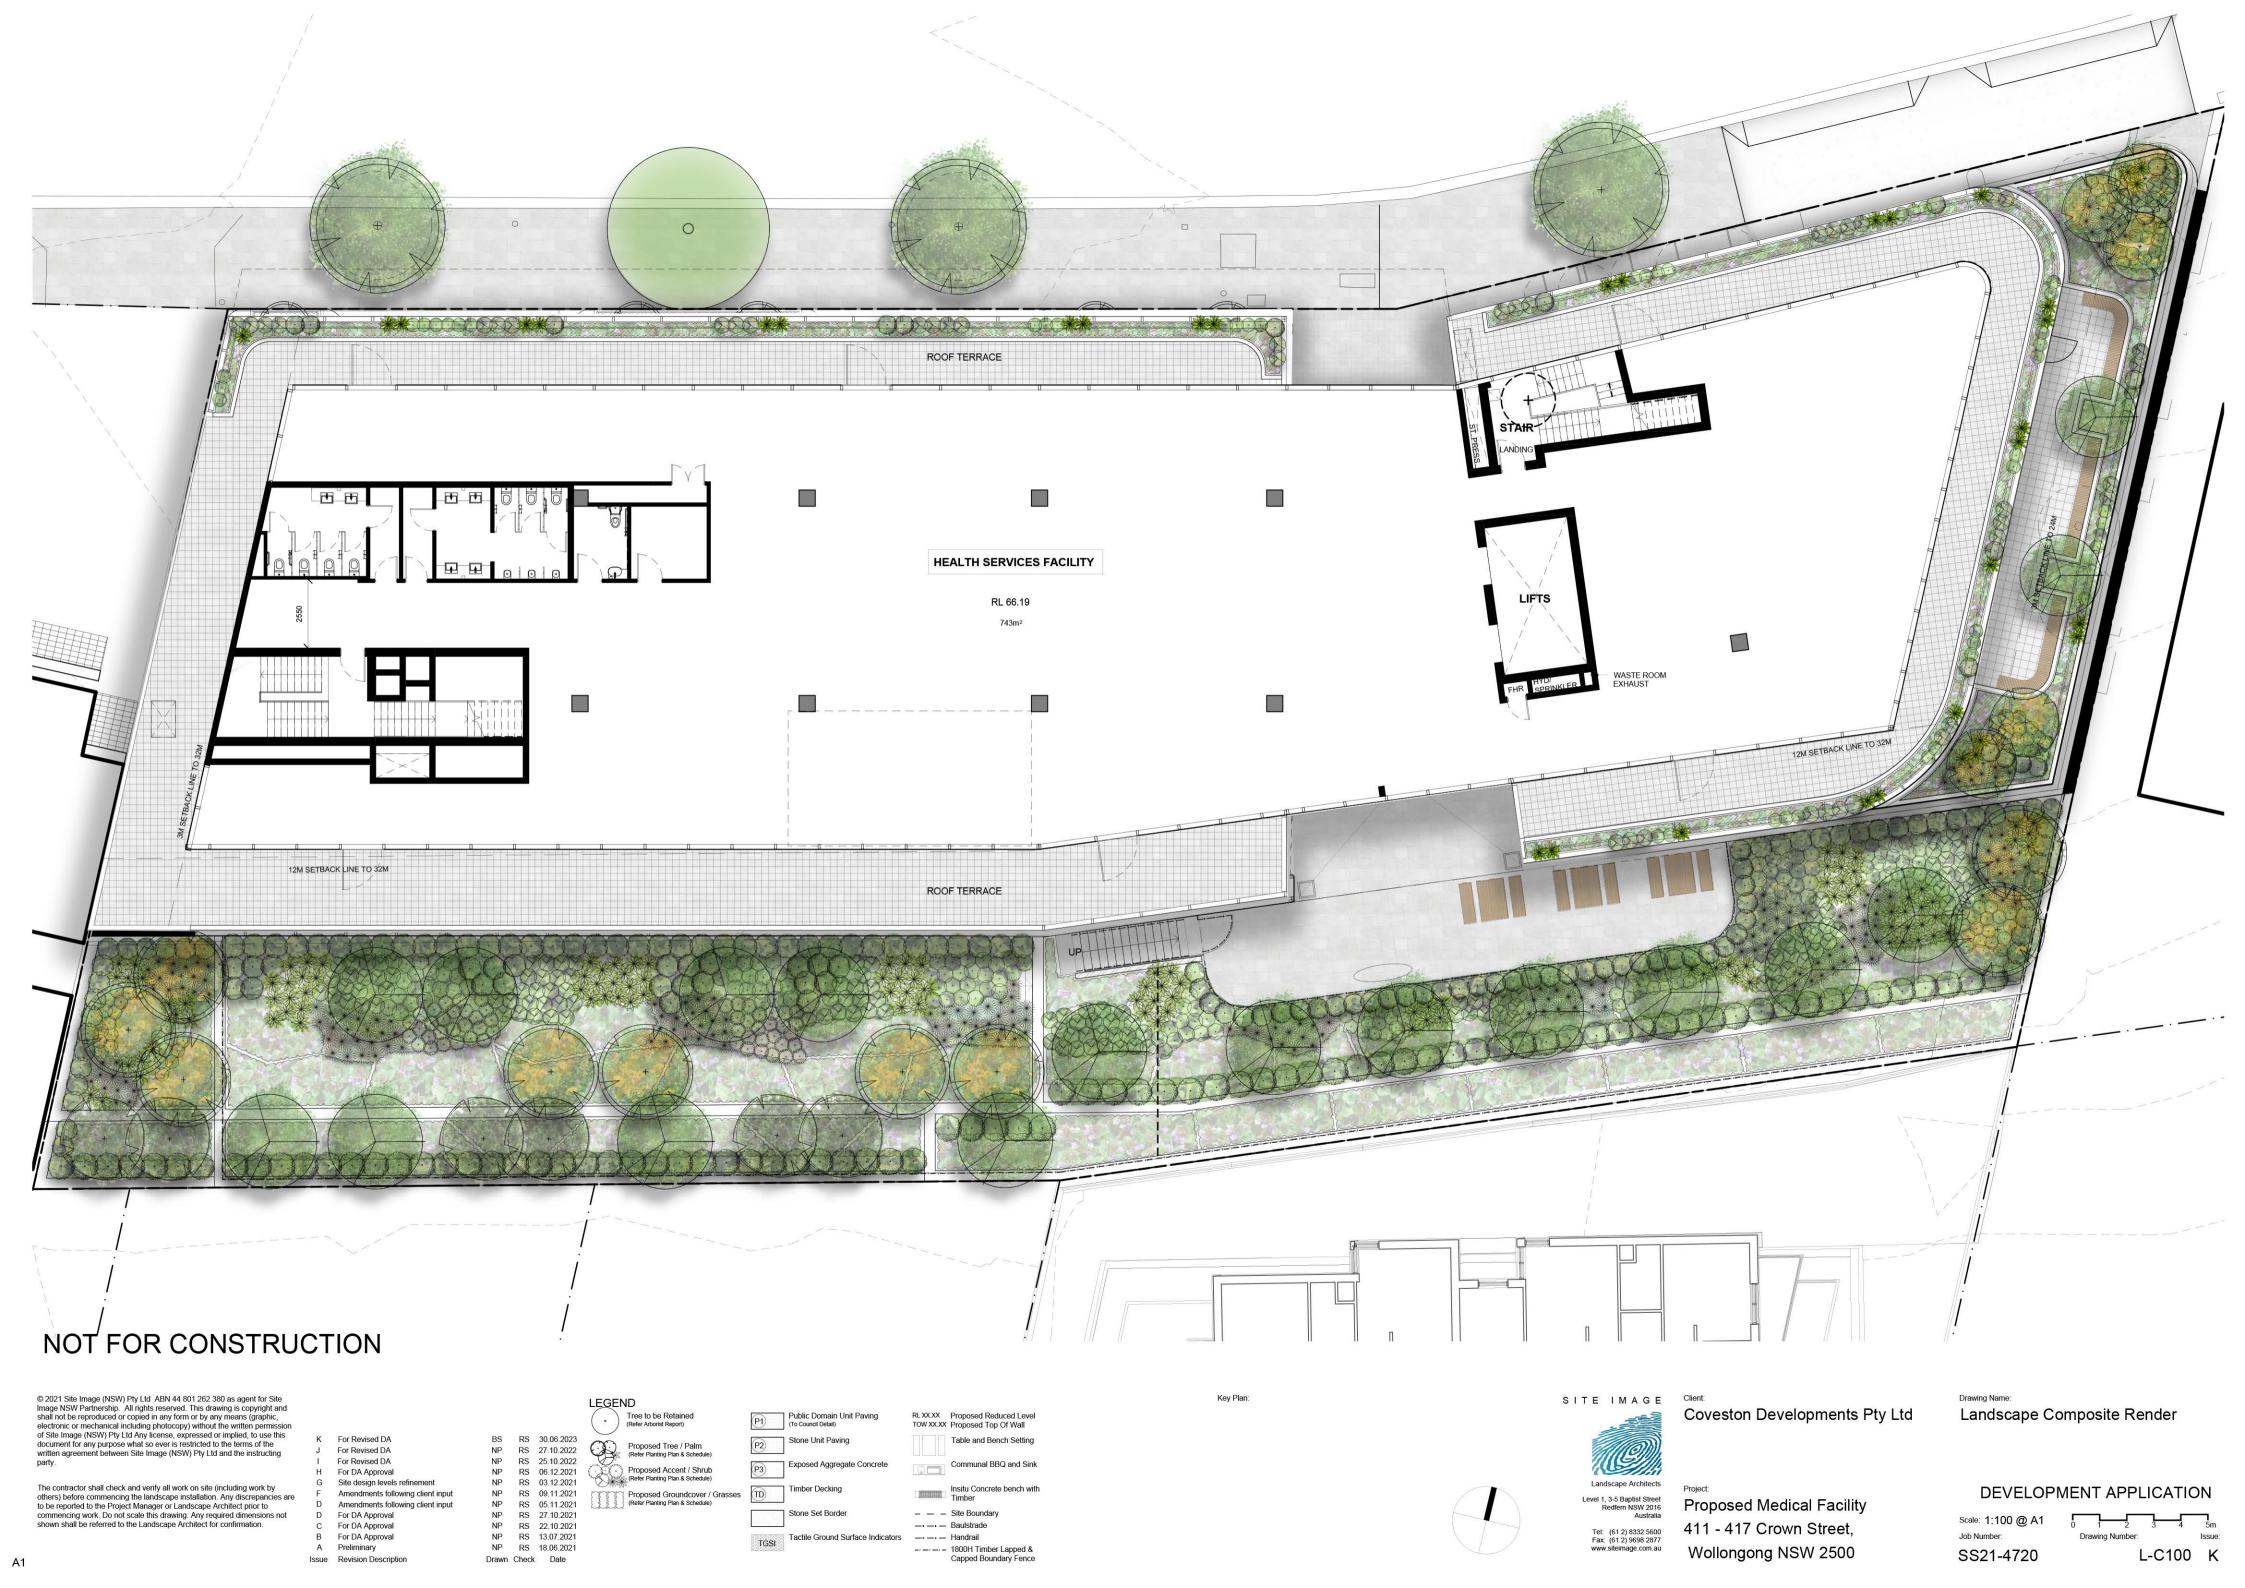

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For Revised DA For Revised DA B For DA Approval A For DA Approval

Issue Revision Description

BS RS 30.06.2023 NP RS 25.10.2022 NP RS 06.12.2021 NP RS 13.07.2021 Drawn Check Date

LEGEND Tree to be Retained Proposed Planting
(Refer Planting Plan & Schedule)

XXXX Soil Depth

Stone Unit Paving Timber Decking

P3 Exposed Aggregate Concrete Stone Set Border

P1 Public Domain Unit Paving
(To Council Detail)

→ → → Baulstrade Tactile Ground Surface Indicators — — — Handrail

RL XX.XX Proposed Reduced Level TOW XX.XX Proposed Top Of Wall Table and Bench Setting

Communal BBQ and Sink

----- 1800H Timber Lapped &

Insitu Concrete bench with Timber — — Site Boundary

Capped Boundary Fence

Key Plan:

Level 1, 3-5 Baptist Street Redfern NSW 2016 Australia Tel: (61 2) 8332 5600


SITE IMAGE Client: Coveston Developments Pty Ltd Landscape Architects

Proposed Medical Facility 411 - 417 Crown Street, Fax: (61 2) 9698 2877 Wollongong NSW 2500

Drawing Name: Landscape Plan Level 1 Terrace

DEVELOPMENT APPLICATION

Job Number: Drawing Number: L-102 D SS21-4720

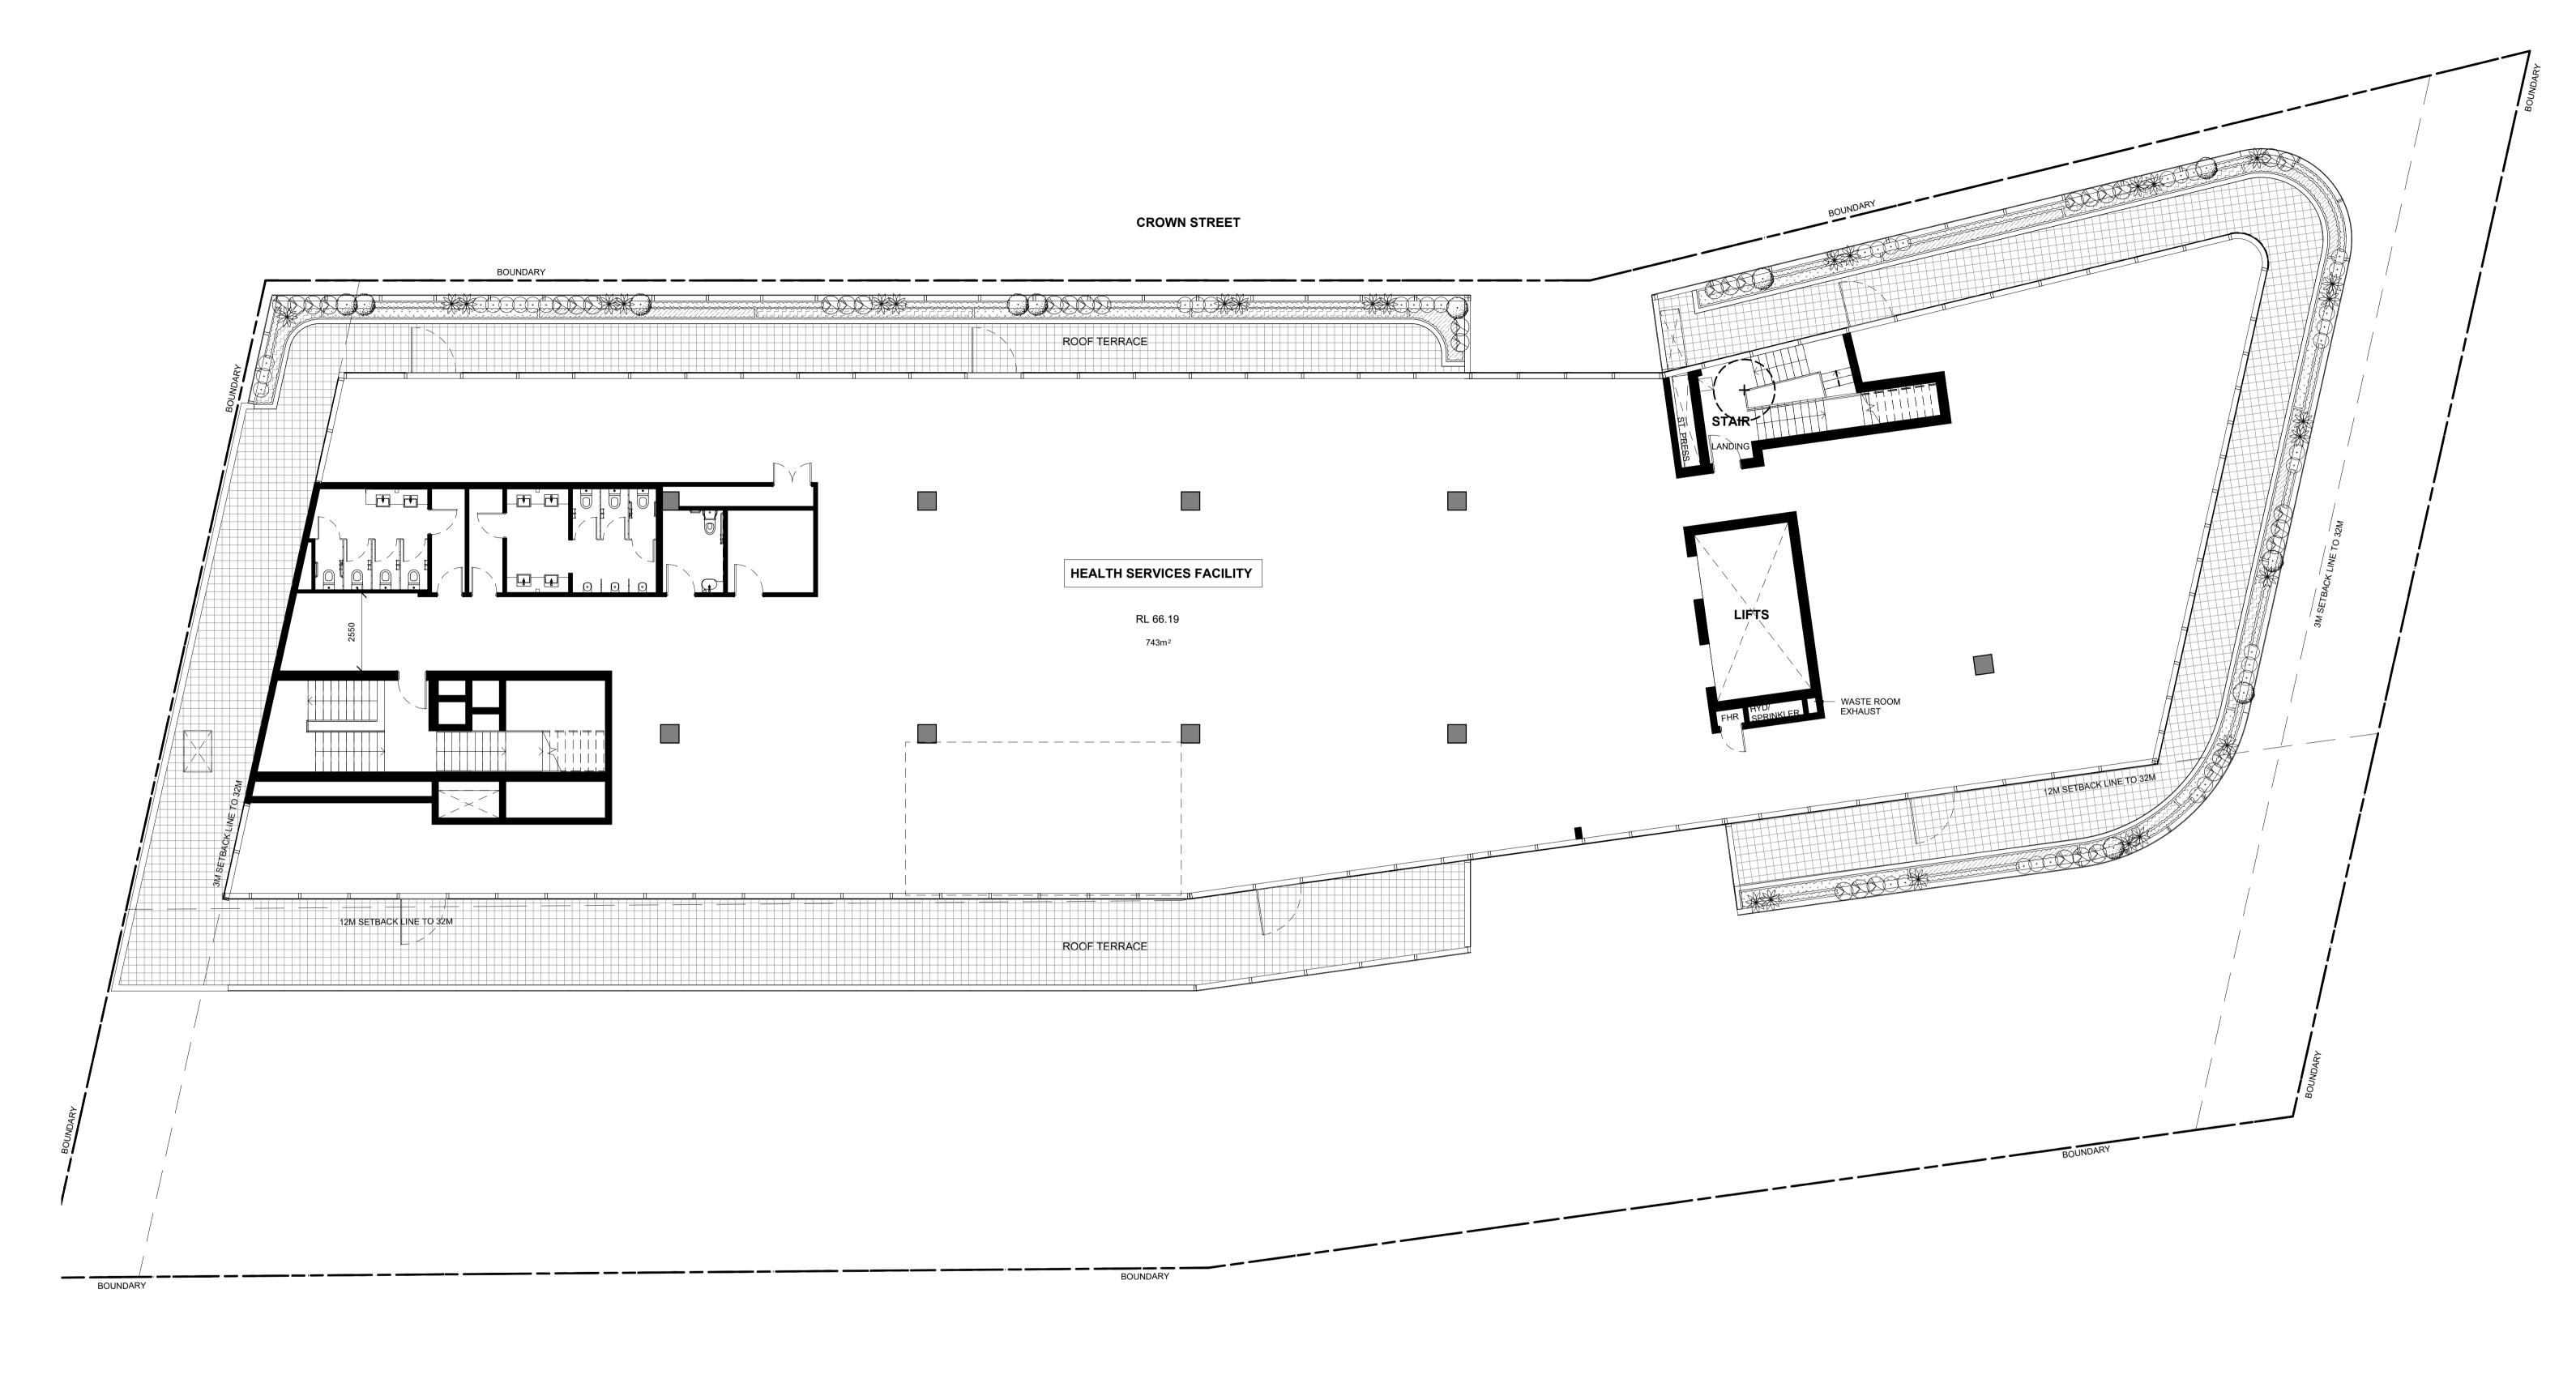

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> B For Revised DA A For Revised DA Issue Revision Description

BS RS 30.06.2023 NP RS 25.10.2022 Drawn Check Date

LEGEND Tree to be Retained (Refer Arborist Report) Proposed Planting
(Refer Planting Plan & Schedule)

Public Domain Unit Paving
(To Council Detail) Stone Unit Paving Exposed Aggregate Concrete

Stone Set Border

Tactile Ground Surface Indicators

Timber Decking

RL XX.XX Proposed Reduced Level

TOW XX.XX Proposed Top Of Wall

Table and Bench Setting

Communal BBQ and Sink — — Site Boundary

Insitu Concrete bench with Timber ----- Baulstrade —∗ —∗ — Handrail

Capped Boundary Fence

-, -, -, - 1800H Timber Lapped &

Key Plan:

SITE IMAGE Client:

Landscape Architects Level 1, 3-5 Baptist Street Redfern NSW 2016 Australia Tel: (61 2) 8332 5600 Fax: (61 2) 9698 2877


Coveston Developments Pty Ltd


Proposed Medical Facility 411 - 417 Crown Street, Wollongong NSW 2500

Drawing Name: Landscape Plan Level 5 Terrace

DEVELOPMENT APPLICATION

Job Number: Drawing Number: SS21-4720 L-105 B

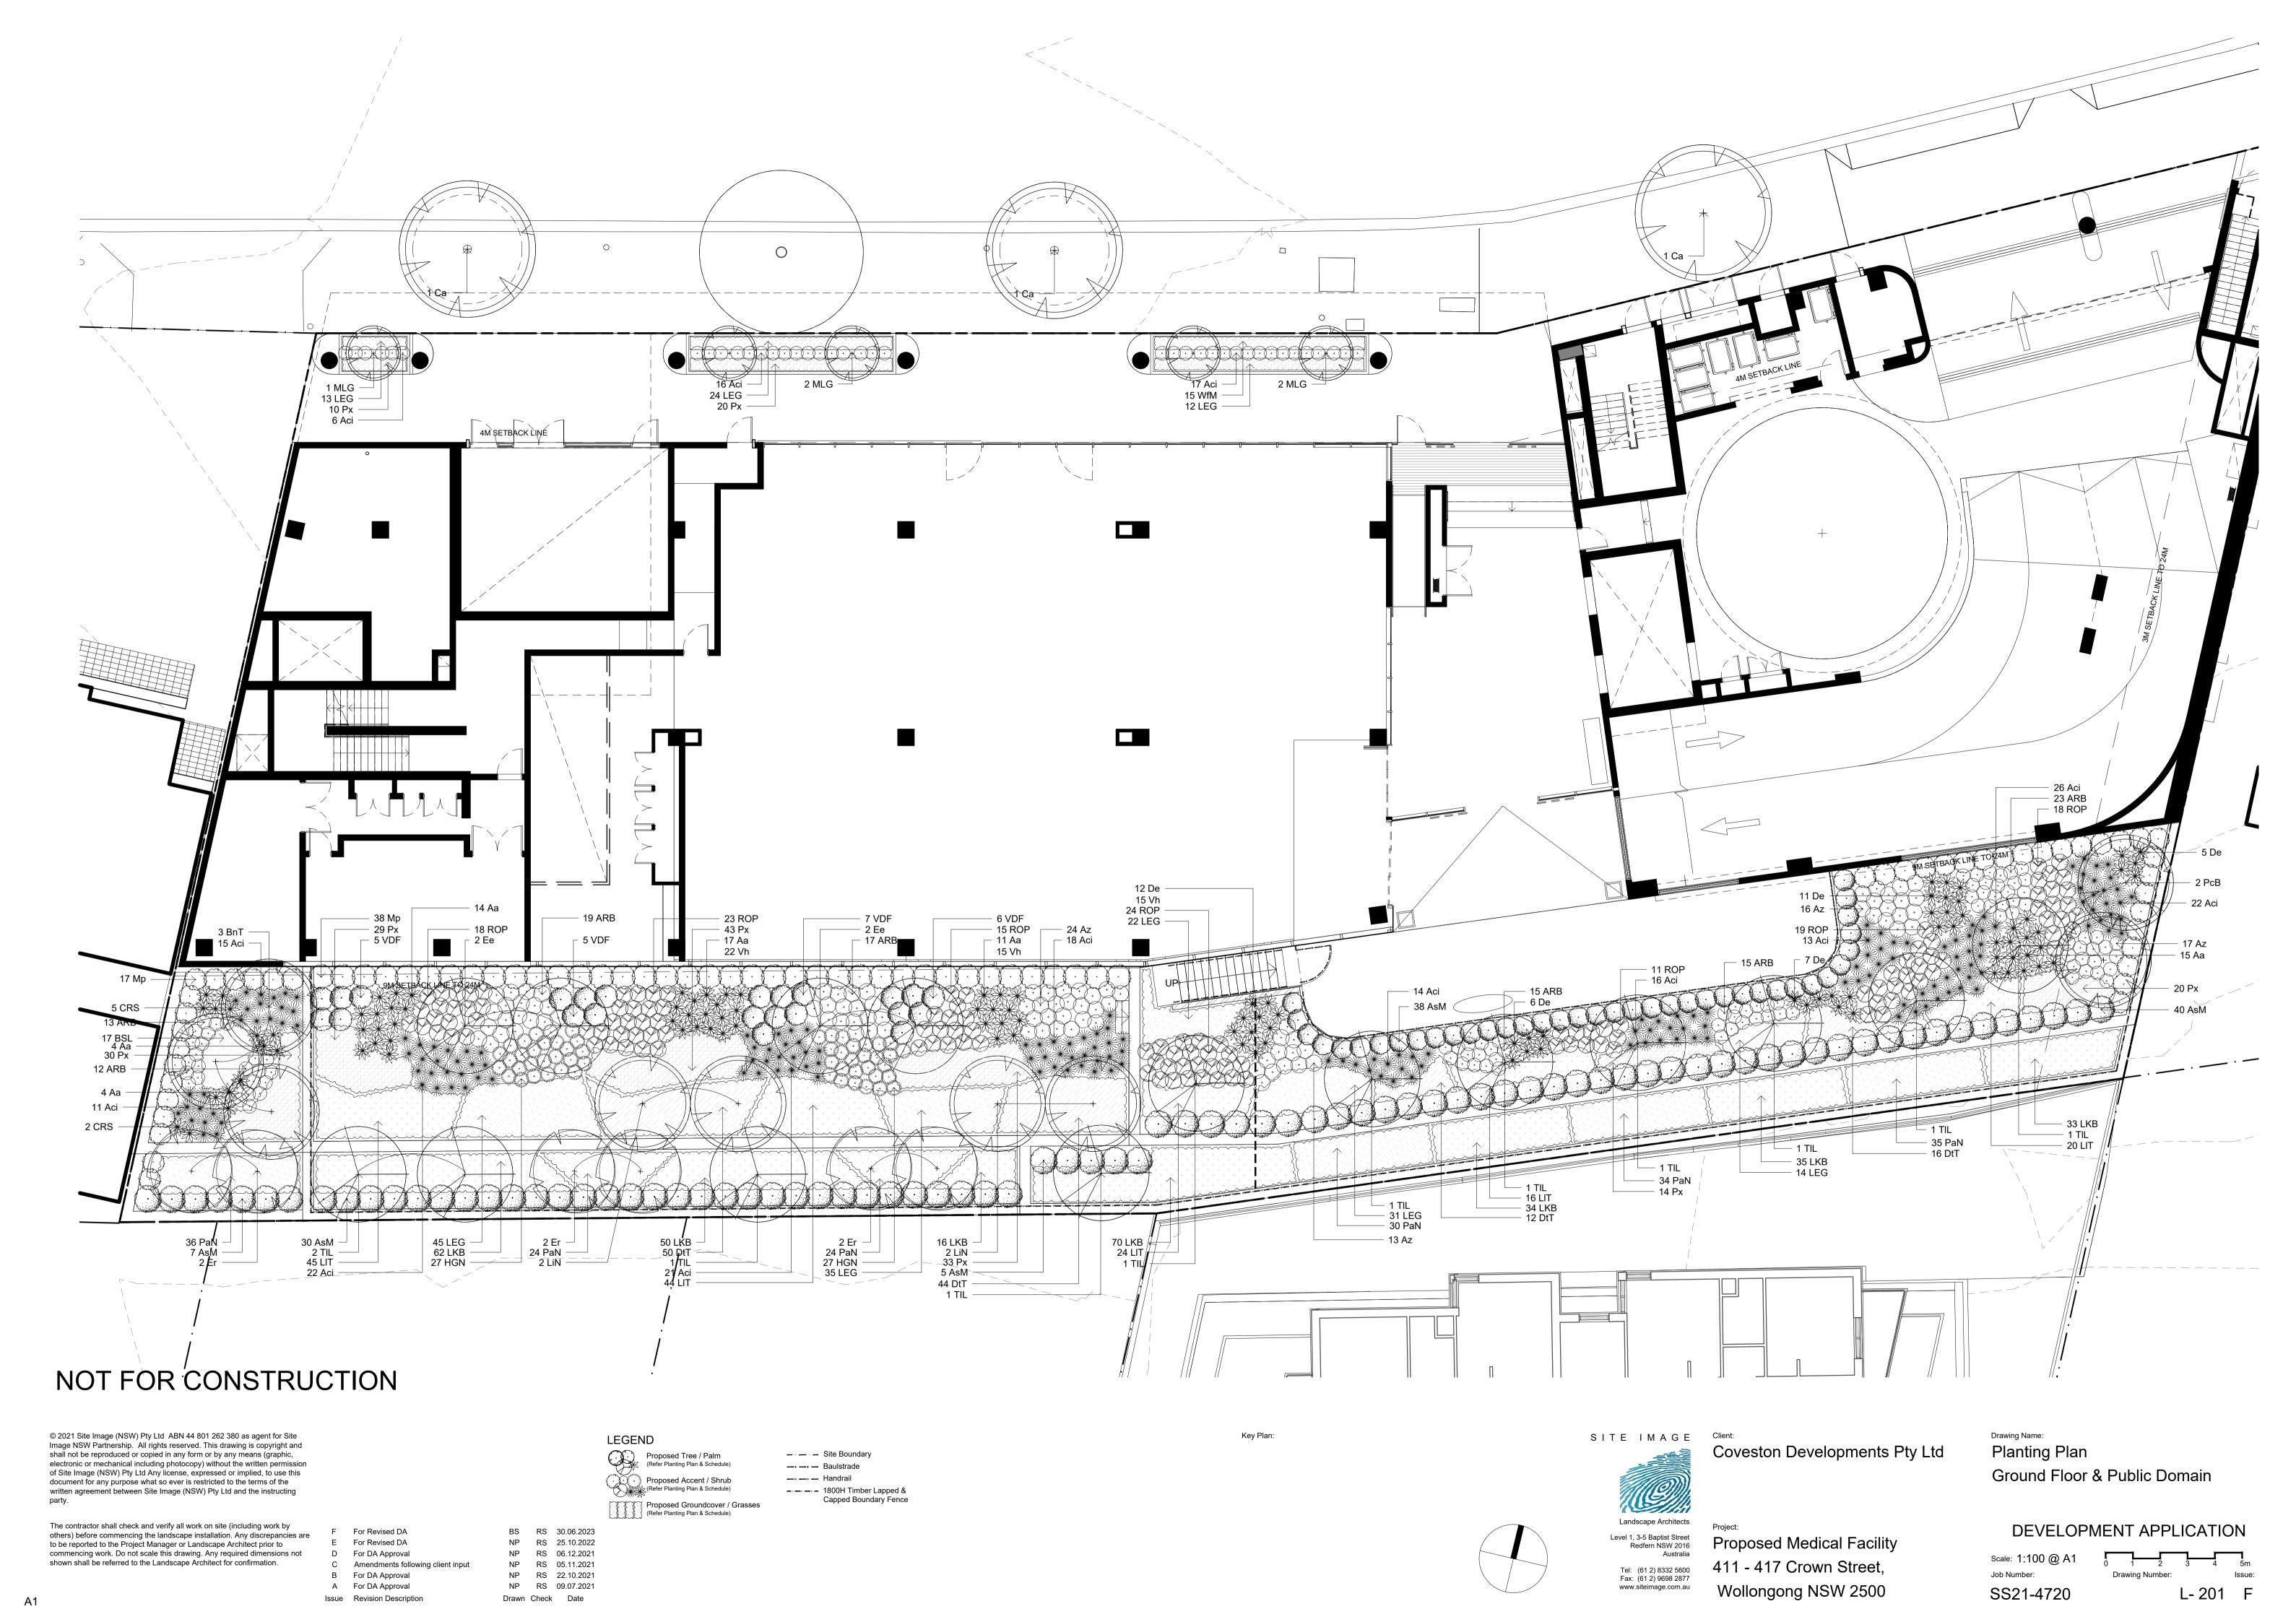

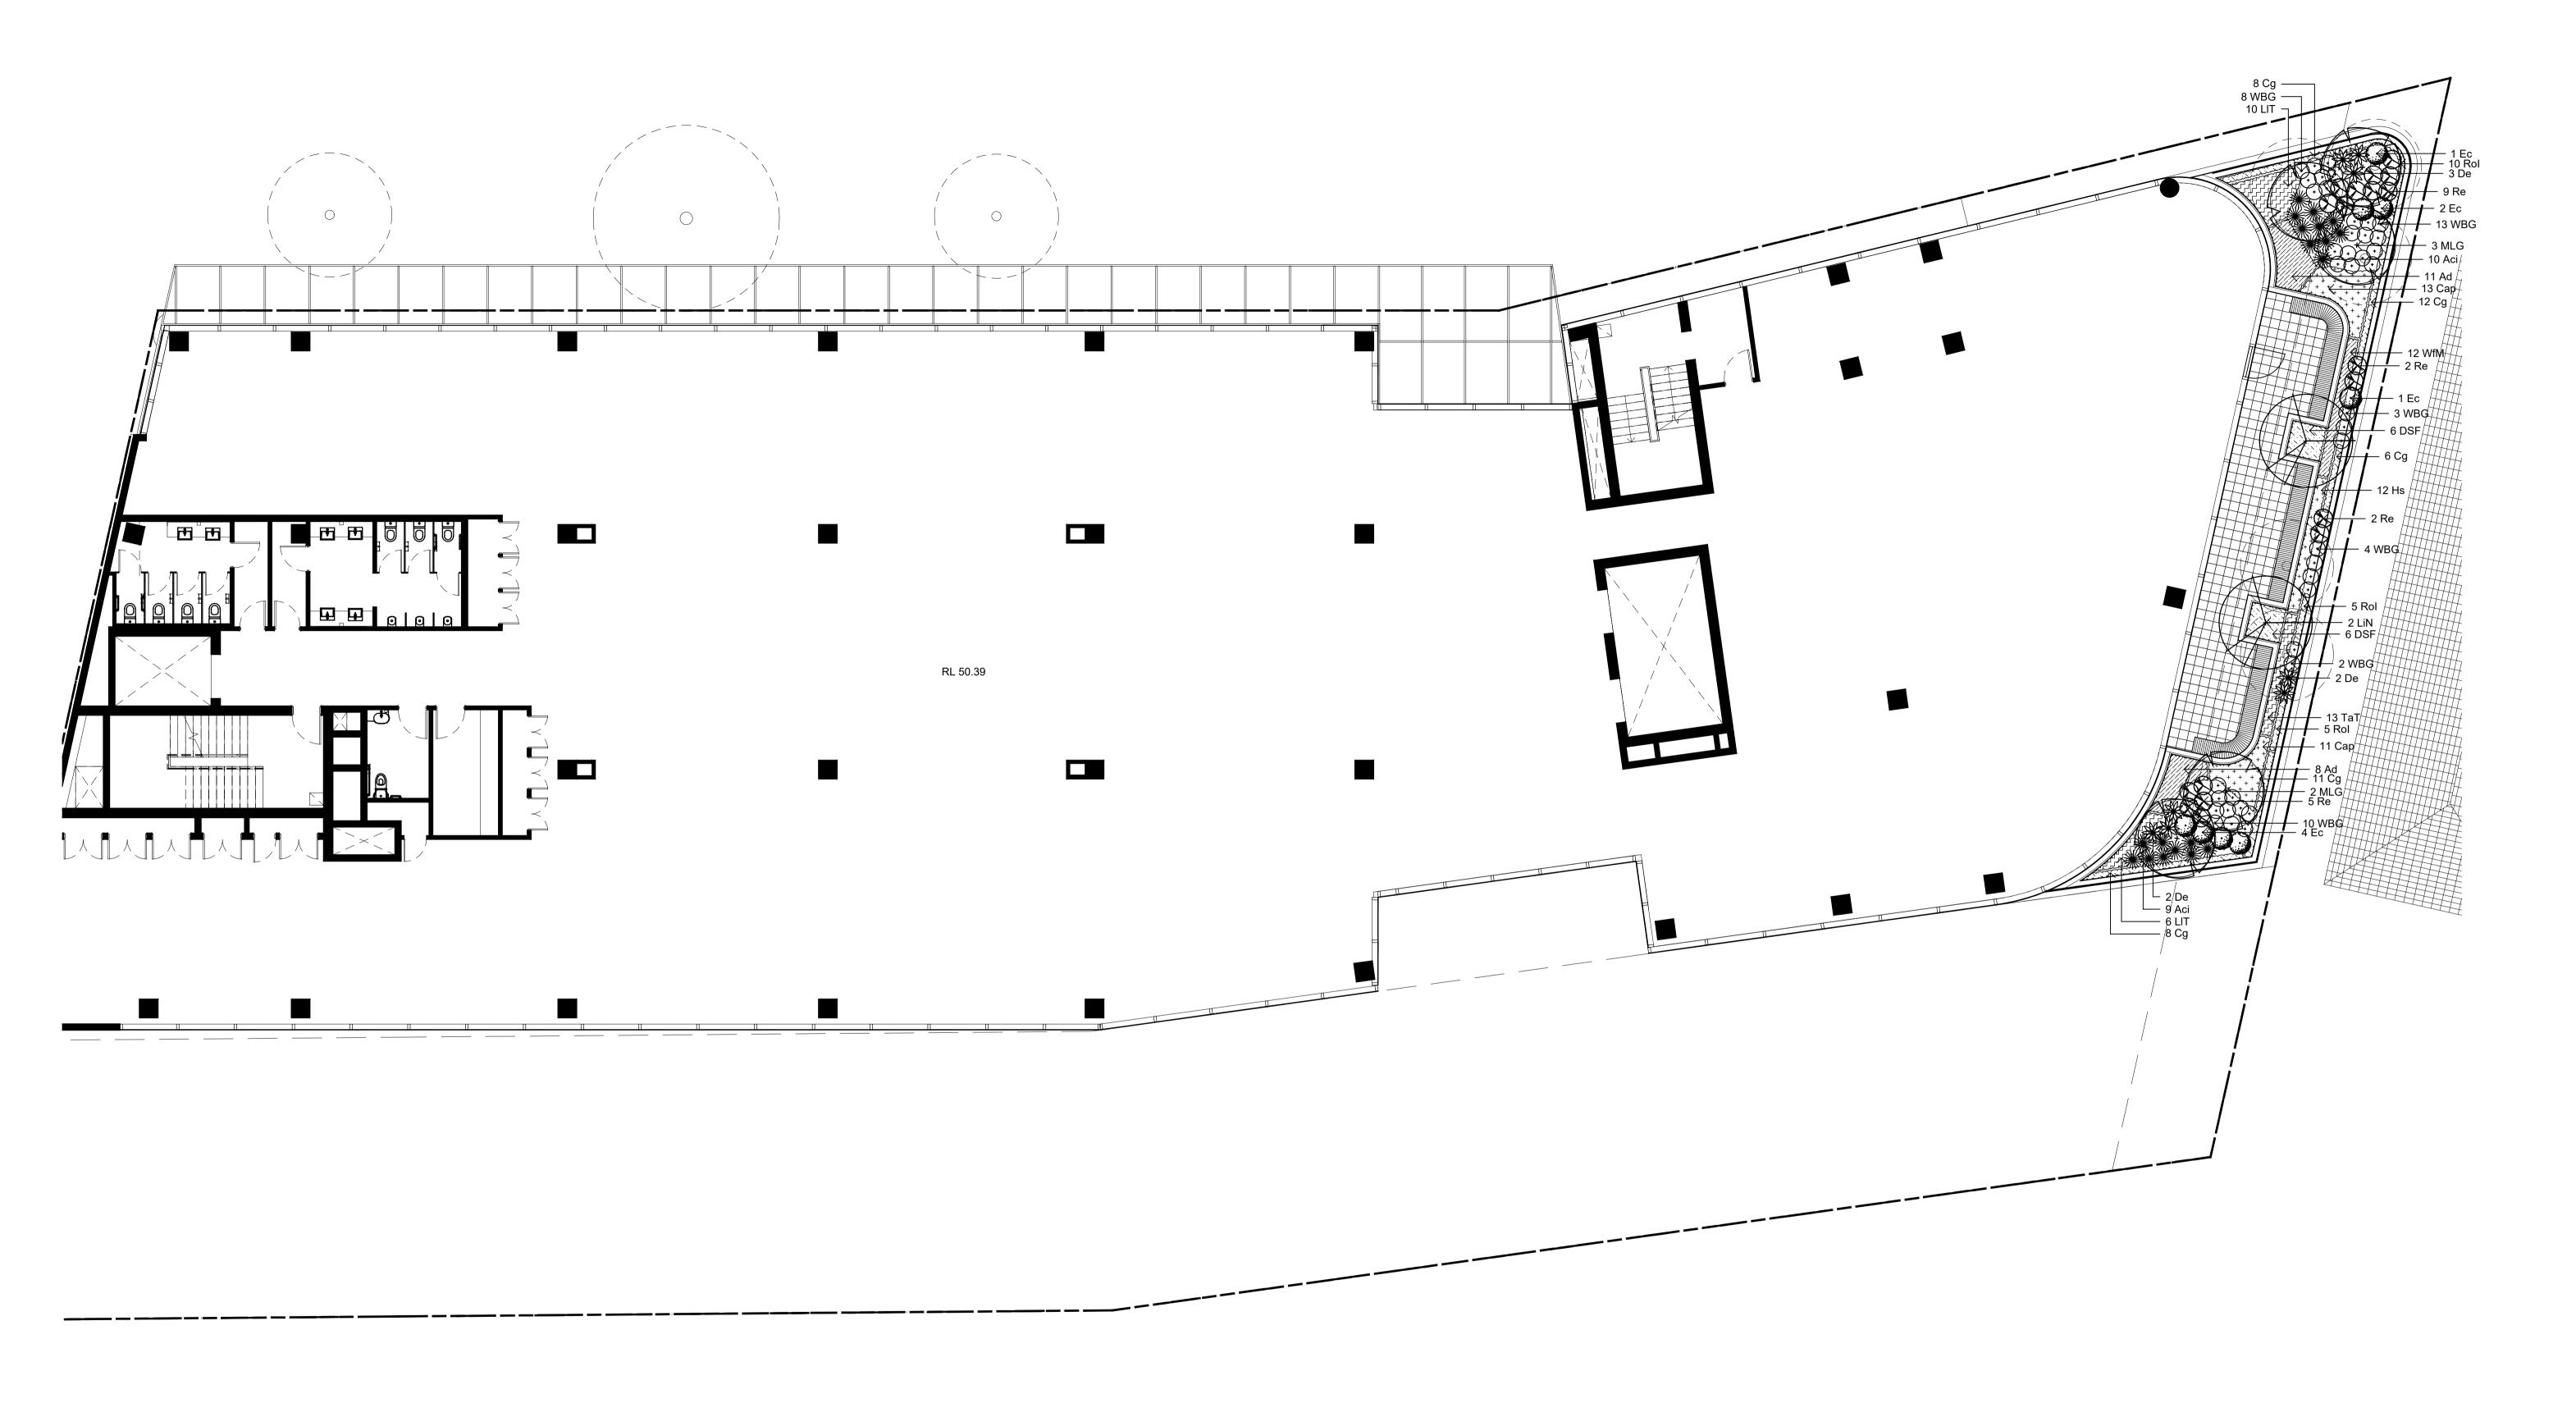

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LEGEND Proposed Tree / Palm
(Refer Planting Plan & Schedule)

Proposed Accent / Shrub
(Refer Planting Plan & Schedule) Proposed Groundcover / Grasses (Refer Planting Plan & Schedule)

— — Site Boundary —• —• — Baulstrade —∎ —∎ — Handrail ------ 1800H Timber Lapped & Capped Boundary Fence Key Plan:




Coveston Developments Pty Ltd

Proposed Medical Facility 411 - 417 Crown Street, Wollongong NSW 2500

Drawing Name: Planting Plan Level 1 Terrace

DEVELOPMENT APPLICATION

Job Number: Drawing Number: L- 202 A SS21-4720

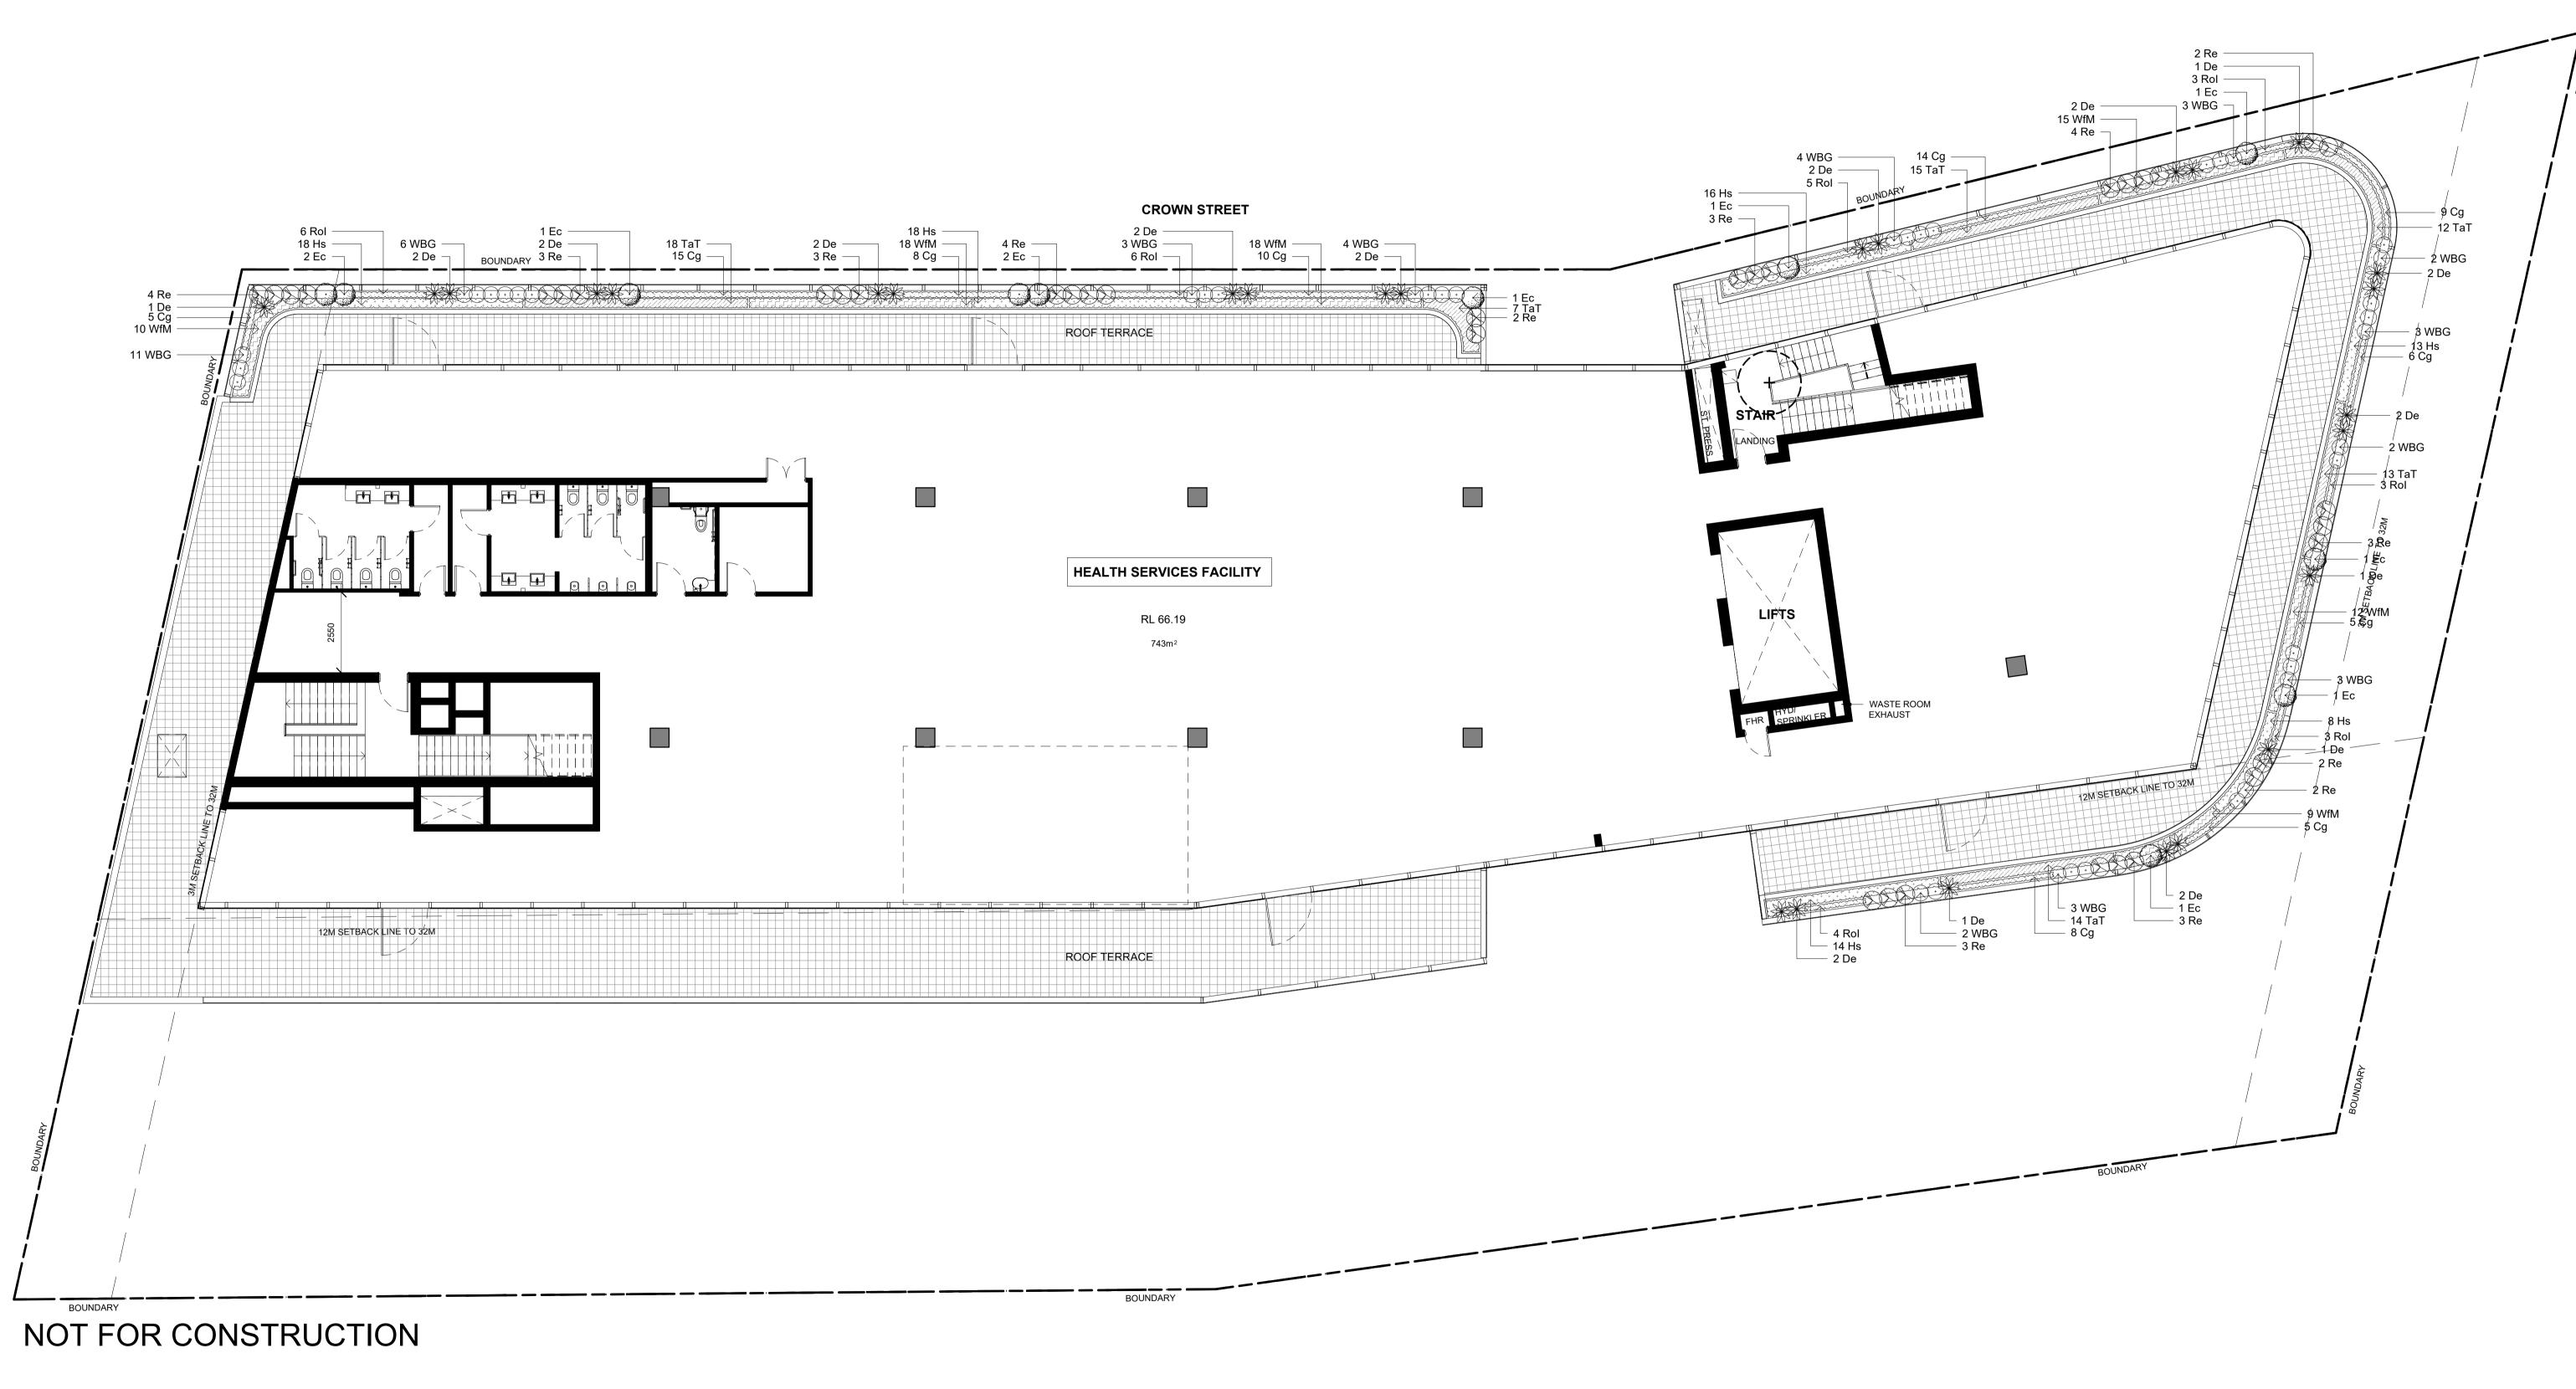

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The contractor shall check and verify all work on site (including work by others) before commencing the landscape installation. Any discrepancies are

to be reported to the Project Manager or Landscape Architect prior to commencing work. Do not scale this drawing. Any required dimensions not shown shall be referred to the Landscape Architect for confirmation.

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A For Revised DA Issue Revision Description

BS RS 30.06.2023 Drawn Check Date

Proposed Tree / Palm
(Refer Planting Plan & Schedule) Proposed Accent / Shrub (Refer Planting Plan & Schedule) Proposed Groundcover / Grasses (Refer Planting Plan & Schedule)

LEGEND

— — Site Boundary --- - Baulstrade —∗ —∗ — Handrail Capped Boundary Fence

Key Plan:

SITE IMAGE Client:

Landscape Architects Level 1, 3-5 Baptist Street Redfern NSW 2016 Australia Tel: (61 2) 8332 5600 Fax: (61 2) 9698 2877

Coveston Developments Pty Ltd

Proposed Medical Facility 411 - 417 Crown Street, Wollongong NSW 2500

Drawing Name: Planting Plan Level 5 Terrace

DEVELOPMENT APPLICATION

Job Number: Drawing Number:

SS21-4720

L-204 A

SPECIFICATION

GENERAL NOTES

References

All plans and details included in the project documents shall be read in conjunction with this specification. All structural and civil works components of the landscape design shall be referenced to engineers' details and specifications. Read this specification in conjunction with the plant and materials schedules on the drawings. If in doubt about any detail or if conflicts are found in the documents, seek advice.

Workmanship and Materials

The whole of the landscape works shall be carried out by a competent, trained and qualified landscape contractor who is experienced in horticultural practices, landscape construction and planting techniques. The landscape contractor shall hold a current Building Contractors License and/or be a financial member of LNA Landscape Association NSW & ACT or equivalent organisations in other states.

EARTHWORKS

Excavation, Trimming and Filling

Except as otherwise noted in the contract, bulk excavation is excluded from the landscape works. After the completion of bulk excavation by others, trim and fill the excavated ground surfaces to achieve design levels to accommodate finish materials as detailed. Prepare the sub-grade surface as required for the various finished ground treatments.

Sub-soil Drainage

Keep the excavated works drained and free of standing water. Allow to supply and install sub-soil drainage pipes as required for the new works to ensure that all gardens are well drained. Connect the sub-soil drainage pipes to the nearest downstream stormwater pits. Include pipe filter socks and course sharp aggregate backfilling of trenches.

HARDWORKS

Furniture, Handrails, Balustrades

Supply and install the scheduled items in accordance with the manufacturer's recommendations, as detailed and in the locations shown on plan. Provide all footings and fixings required for the items to be stable and in accordance with applicable codes and standards.

Garden Walls, Fences, Steps, TGSI and Edging

Construct garden walls, fences, steps, TGSI and edging as shown on plan, as detailed and of the material scheduled. Provide footings, step nosings, tactile surfaces to comply with Australian Standards and applicable legislation. Refer to engineer's details for structural retaining walls, concrete stairs, concrete strength, reinforcing and joint placement.

Continuous, Unit and Loose Pavement

Install the scheduled material pavement to the locations shown on plan. Ensure that all subgrade/subsurface works are complete prior to commencing paving. Confer with the engineer to ensure the structural integrity of the subgrade. Ensure that the base course under paved surfaces is a continuous plane offering a constant depth of bedding material not exceeding 50mm. If laying unit pavers in a cement mortar bed on a concrete sub-base ensure that joints in paving match the location of joints in the concrete. Refer to engineer's details for heavy duty slabs, concrete stairs, concrete strength, reinforcing, and joint type and placement.

SOFTWORKS

Site Soil Testing

Where site soil is to be retrieved from site and stored on site for reuse, undertake at least two (2) soil tests in locations as advised by the Project Manager or as shown on the plans. Provide results and recommendations regarding soil additives for the benefit of healthy plant growth and to adjust the soil components to achieve an appropriate planting medium for successful plant development.

Subsoil

Excavate and/or fill all garden beds to bring the top of subsoil to at least 300mm below finished design soil levels. Excavate all turf areas to bring the subsoil to at least 100mm below finished design levels. In all areas shape the subsoil to fall to subsoil drains where applicable. Do not excavate within the drip line of trees and shrubs to be retained. Cultivate or rip the subsoil to a further depth of 100mm before placing top soil. Remove stones of size exceeding 25mm, clods of earth exceeding 50mm, and weeds, rubbish or other deleterious material brought to the

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to be reported to the Project Manager or Landscape Architect prior to

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others) before commencing the landscape installation. Any discrepancies are

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surface during cultivation. Do not disturb services or existing tree roots. If necessary cultivate these areas by hand. During cultivation, thoroughly mix in materials required to be incorporated into the subsoil, as recommended in the soil testing results and to manufacturer's recommendations. Trim the surface to design levels again after cultivation.

Topsoil

Import topsoil for the garden and turf areas, unless the topsoil can be provided from material recovered from the site, as recommended in the soil testing results. Spread the topsoil on the prepared subsoil and grade evenly, compact lightly and uniformly in 150mm layers. Avoid differential subsidence and excess compaction and produce a finished topsoil surface which has the following characteristics:

- Finished to design levels, allowing for mulch or turf, which is to finish flush with adjoining hard surfaces such as paths and
- Smooth and free from inorganic matter, stones or clods of
- Graded to drain freely, without ponding, to catchment and/or sub-soil drains:
- Graded evenly to adjoining surfaces; and
- Ready for planting.

Provide, in accordance with AS 4454, well rotted vegetative material or animal manure, free from harmful chemicals. inorganic matter, grass, weeds and the reproductive parts of unwanted plants.

Fertiliser

Provide proprietary fertilisers, delivered to the site in sealed containers marked to show manufacturer or vendor, weight, fertiliser type, N:P:K ratio, recommended uses, application rates and safety procedures. Apply appropriate fertiliser suited to the provenance of plants (indigenous or exotic) included in the

Supply plants in accordance with the landscape design drawings and schedules, which have the following

- Large healthy root systems, with no evidence of root curl, restriction or damage;
- Vigorous, well established, free from disease and pests, of good form consistent with the species/variety;
- Hardened off, not soft or forced, and suitable for planting in the natural climatic conditions prevailing at the site in full sun, partial shade or full shade conditions;
- Grown in final containers for not less than twelve weeks; Trees, unless required to be multi-stemmed, shall have a
- single leading shoot; and
- Containers shall be free from weeds and of appropriate size in relation to the specified plant size.

Plant Installation

Following excavation of the planting hole, place and spread 15gms of wetting agent pre-mixed with one (1) litre of water. Place the plant correctly orientated to north or for best presentation. Backfill the planting holes with specified topsoil mixture. Lightly tamp and water to eliminate air pockets. Ensure that the backfill soil is not placed over the top of the root ball and that the root ball is not higher than the soil in which it is planted. Apply fertiliser, as specified around the plants in the soil at the time of planting.

Embankment Stabilisation

Where necessary and shown on the drawings prevent soil erosion or soil movement by stabilising embankments as follows. As a minimum this should be on slopes steeper than or equal to 1:3 gradient. Stabilise embankments using biodegradable fibre reinforced heavy weight jute fabric. Lay fabric from top to bottom of slope. Install in accordance with manufacturer's specification, including 300 x 300mm anchor trench at top and bottom of slope, backfilled with soil over the fabric and compacted into the trenches. Using U-shaped galvanised steel pegs at 1000 mm centres generally and 250mm centres at edge overlaps, secure the fabric to the prepared soil surface. Plant through the fabric after it is installed.

Root Barrier

Supply and install root control barriers to all new tree plantings adjacent to walls, paths, kerbs and all service trenches, where their proximity poses a threat to the stability of the built infrastructure. Install in accordance with manufacturer's recommendations.

Mulch

Unless noted otherwise, mulch shall be approved proprietary recycled wood fibre or pine bark material. Place mulch in all garden beds to a depth of 75mm after all specified plants are installed. Keep mulch clear of all plant stems and rake to an even plane, flush with the surrounding surfaces evenly graded between design surface levels. Over fill to allow mulch to settle to the specified depth.

Stakes and Ties

Stakes shall be durable hardwood, straight, free of knots and twists, pointed at one end, in the following quantities and sizes for each of the various plant pot sizes:

- Plants >25 lt: 1 off 38 x 38 x 1200mm:
- Semi-advanced plants >75 lt: 2 off 50x50x 1800mm; • Advanced plants >100 lt: 3 off 50 x 50 x 2400mm.

Turf shall be delivered to site as 25mm minimum thick cut rolls. Obtain turf from a specialist grower of cultivated turf. Turf shall have an even thickness, free from weeds and other foreign matter. Deliver turf to the site within 24 hours of being cut and lay it within 24 hours of delivery. Prevent it form drying out between cutting and laying. Lay the turf in the following manner:

- In stretcher pattern, joints staggered and close butted;
- Parallel long sides of level areas, with contours on slopes;
- To finish flush, after lightly tamping, with adjacent finished surfaces and design levels.

Species: Stenotaphrum secundatum Sir Walter Soft-leaf Buffalo.

IRRIGATION

Scope: Unless otherwise noted or instructed irrigate all planted areas shown on plans including planters, tubs, gardens, turf and the like.

The irrigation system shall be an automatic permanent system, with an irrigation controller self operated via a soil moisture sensor. The system shall be calibrated to deliver the optimum rate and volume of water appropriate to the type of plants in the design. The system shall be adjustable and fully serviceable. The layout of the entire irrigation system shall focus on delivering the required amount of water to maintain healthy and vigorous growth. The irrigation system shall be such that, component theft, vandalism, over-spray and wetting of paths shall be reduced to a minimum or completely eliminated by the use of drip, pop-up sprinklers and judiciously placed fixed spray emitters. Generally do not use fine mist emitters that provide a drifting mist that may wet paths and the buildings unless specifically required by the design.

LANDSCAPE MAINTENANCE

The Landscape Contractor shall rectify defects during installation and that become apparent in the works under normal use for the duration of the contract Defects Liability Unless contracted otherwise, the Landscape Contractor shall maintain the contract areas by the implementation of industry accepted horticultural practices for 52 weeks from Practical Completion of the works. The landscape maintenance works shall include, but not be limited

- Replacing failed plants;
- Pruning; Insect and pest control;
- Fertilising;
- Maintaining and removing stakes and ties;
- Maintaining mulch;
- Mowing and top dressing;
- Irrigation and watering;
- Erosion control; and
- Weeding and rubbish removal.

Maintenance Log Book

Implement and keep a maintenance log book recording when and what maintenance work has been undertaken and what materials, actions and decisions have been used, implemented and concluded to keep the landscape always looking its best. Enter data daily and review information every 2 weeks. Observe trends and develop a maintenance regime around seasonal and observed event occurrences.

Maintenance Activities

During the defects maintenance period schedule the following activities to occur on a timely basis.

 Plant replacement - Replace plants that have failed to mature, die or are damaged. Replacement plants shall be in a similar size and quality and identical species or variety to the plant that has failed. Replacement of plants shall be at

the cost of the landscape contractor unless advised otherwise. If the cause of the failure is due to a controllable situation then correct the situation prior to replacing plants. Observe and replace failed plants within 2 weeks of observation.

- Pruning Prune dead wood, broken limbs, dead or infected foliage and as needed to develop strong, healthy plants to achieve the shape and form expected of the plant type. Observe daily and prune plants on a needs basis.
- Insect, disease and pest control Avoid spraying:
- o if ever possible:
- o in wet weather or if wet weather is imminent; if target plants are still wet after rain;
- in windy weather; and
- if non-target species are too close.

Immediately report to the Project Manager any evidence of intensive weed infestation, insect attack or disease amongst plant material. Submit all proposals to apply chemicals and obtain approval before starting this work. When approved, spray with herbicide, insecticide, fungicide as appropriate in accordance with the manufacturers' recommendations. Observe daily and act as necessary to control any infestation or disease. Record in the logbook all relevant details of spraying activities including:

- Product brand / manufacturer's name,
- Chemical / product name,
- Chemical contents.
- Application quantity and rate,
- Date of application and location,
- Results of application, and Use approval authority.
- Fertilising Fertilise gardens with a proprietary slow release fertiliser applied in accordance with the manufacturer's directions and recommendations. Apply 6-12 monthly. Record in the logbook all relevant details of fertilising including:

Product brand / manufacturer's name,

- Fertiliser / product name,
- Application quantity and rate, and
- Date of application and location.
- Stakes and ties Adjust and replace as required to ensure plants remain correctly staked. Remove those not required at the end of the planting establishment period (Defects Liability Period). Inspect and act at least every 2 weeks.
- Maintaining mulch Maintain the surface in a clean, tidy and weed free condition and reinstate the mulch as necessary to ensure correct depth as specified. Observe weekly and replenish mulch as required.
- **Mowing and top dressing** Mow the turf to maintain a grass height of between 30-50mm. Do not remove more than one third of the grass height at any one time. Remove grass clippings from the site after each mowing. Top dress to a maximum of 10mm to fill depressions and hollows in the surface. Mow weekly/fortnightly in warmer months. Mow monthly or as required in cooler months. Top dress at approximately 6 monthly intervals.
- Irrigation and watering Maintain the irrigation system to sure that each individual plant receives the required amount of water to maintain healthy and vigorous growth. Adjust and calibrate as required. Provide additional watering, if necessary but inspect irrigation weekly and make repairs as necessary.
- Erosion control Where necessary, maintain the erosion control fabric in a tidy and weed free condition and reinstate as necessary to ensure control measures are effective where deemed necessary. Inspect every 2 weeks and act to repair any damage as soon as possible.
- Weeding and rubbish removal During the plant establishment period remove by hand, rubbish and weed growth that may occur or re-occur throughout all planted, mulched and paved areas. The contractor shall target weeds that are capable of producing a major infestation of unwanted plants by seed distribution. Whenever possible, time weed removal to precede flowering and seed set. Constant observation and removal of weeds is essential.

411-417 Crown Street, Wollongong

			Mature Size			
Abbrev.	Botanic Name	Common Name	H x W	Pot Size	Density	Q
GROUND F	LOOR PLANT SCHEDULE					
TREES & PA						
BnT	<i>Betula nigra</i> 'Tropical'	Tropical Birch	15.0 x 6.0	200L	As Shown	3
Ca	Cuapniopsis anacardioides	Tuckeroo	15.0 x 15.0	200L	As Shown	3
Ee	Elaeocarpus eumundii	Smooth Quandong	15.0 x 10.0	200L	As Shown	2
Er	Elaeocarpus reticulatus	Blueberry Ash	9.0 x 4.0	200L	As Shown	E
LiN	Lagerstroemia indica 'Natchez'	Crepe Myrtle	4.0 x 6.0	200L	As Shown	4
MLG	Magnolia grandiflora 'Little Gem'	Little Gem Magnolia	5.0 x 4.0	200L	As Shown	5
PcB	Pyrus calleryana 'Bradford'	Bradford Ornamental Pear	15.0 x 10.0	200L	As Shown	2
TIL	Tristaniopsis laurina 'Luscious'	Water Gum	15.0 x 8.0	200L	As Shown	1
SHRUBS &	ACCENTS					
AsM	Acmena smithii 'Minor'	Lilly Pilly	4.0 x 2.0	45L	As Shown	12
Aa	Asplenium australasicum	Birds Nest Fern	1.0 x 1.0	300mm	As Shown	6
ARB	Alpinia caerulea 'Red Back'	Red Back Native Ginger	2.0 x 1.0	200mm	As Shown	13
Az	Alpinia zerumbet	Variegated Shell Ginger	1.5 x 1.0	200mm	As Shown	7
Aci	Arthropodium cirratum	Renga Renga Lilly	0.9 x 0.9	200mm	As Shown	19
CRS	Cordyline fruticosa 'Red Sensation'	Cordyline	2.0 x 1.0	300mm	As Shown	-
De	Doryanthes excelsa	Gymea Lilly	2.0 x 2.0	200mm	As Shown	4
HGN	Hymeonsporum flavum 'Gold Nugget'	Native Frangipani	0.75 x 0.75	200mm	As Shown	5
Мр	Murraya paniculata	Mock Orange	3.0 x 2.0	300mm	As Shown	5
ROP	Rhapiolepis indica 'Oriental Pearl'	Oriental Pearl Indian Hawthorn	1.5 x 1.0	200mm	As Shown	12
VDF	Viburnum 'Dense Fence'	Dwarf Viburnum	1.8 x 1.2	300mm	As Shown	2
CDACCEC 8	CROUND COVERS					
BSL	GROUND COVERS Blechnum gibbum 'Silver Lady'	Silver Lady Fern	1.2 x 1.0	140mm	5/m ² or 2/LM	1
		·				
DtT	Dianella tasmanica 'Tasred'	NZ Flax	0.6 x 0.6	140mm	5/m ² or 2/LM	12
LEG	Liriope muscari 'Evergreen Giant'	Turf Lilly	0.6 x 0.6	140mm	5/m² or 2/LM	1
LKB	Lomandra hystrix 'Katie Belles'	Katie Belles	1.5 x 1.5	140mm	5/m² or 2/LM	30
LIT	Lomandra longifolia 'Tanika'	Mat Rush	0.8 x 0.8	140mm	5/m ² or 2/LM	14
					5/m ² or 2/LM	
Px	Philodendron xanadu	Xanadu	1.0 x 1.0	140mm		19
PaN	Pennisetum alopecuroides 'Nafray'	Fountain Grass	1.2 x 0.8	140mm	5/m ² or 2/LM	18
Vh	Viola hederacea	Native Violet	0.1 x 0.5	140mm	5/m² or 2/LM	5
WfM	Westringia fruticosa 'Mundi'	Creeping Coastal Rosemary	0.5 x 1.5	140mm	5/m² or 2/LM	1
Level 1 PL	ANT SCHEDULE					
Trees		White Co. No. 11		2001		
LiN	Lagerstroemia indica 'Natchez'	White Crepe Myrtle	6.0 x 40	200L	As Shown	
MLG	Magnolia grandiflora 'Little Gem'	Little Gem Magnolia	5.0 x 4.0	200L	As Shown	
SHRUBS &						
Ec	Echium candicans	Pride of Maderia	1.8 x 1.2	300mm	As Shown	
Re	Russelia equisetiformis	Firecracker Plant	1.8 x 0.45	200mm	As Shown	1
WBG	Westringia fruticosa 'Blue Gem'	Coastal Rosemary	1.5 x 1.3	200mm	As Shown	2
GRASSES &	GROUND COVERS					
Ad	Alternanthera dentata	Alternanthera	0.7 x 1.5	140mm	5/m² or 2/LM	2
		Pig Face	0.2 x 1.5	140mm	5/m² or 2/LM	4
Cg	Carpobrotus glaucascense	1.8.400	0.2 / 2.5		- , 2 - , ,	
		-		140mm	5/m or 2/IM	2
Сар	Chrysocephalum apiculatum	Yellow Buttons	0.3 x 0.5	140mm	5/m ² or 2/LM	
Cap DSF	Chrysocephalum apiculatum Dichondra argentea 'Silver Falls'	Yellow Buttons Silver Falls Kidney Weed	0.3 x 0.5 0.1 x 1.5	140mm	5/m ² or 2/LM	1
Cap DSF Hs	Chrysocephalum apiculatum Dichondra argentea 'Silver Falls' Hibbertia scandens	Yellow Buttons	0.3 x 0.5		5/m ² or 2/LM 5/m ² or 2/LM	1
Cap DSF	Chrysocephalum apiculatum Dichondra argentea 'Silver Falls'	Yellow Buttons Silver Falls Kidney Weed	0.3 x 0.5 0.1 x 1.5	140mm	5/m ² or 2/LM	1
Cap DSF Hs	Chrysocephalum apiculatum Dichondra argentea 'Silver Falls' Hibbertia scandens	Yellow Buttons Silver Falls Kidney Weed Snake Vine	0.3 x 0.5 0.1 x 1.5 0.5 x 2.0	140mm 140mm	5/m ² or 2/LM 5/m ² or 2/LM	1 1 1
Cap DSF Hs LIT RoI	Chrysocephalum apiculatum Dichondra argentea 'Silver Falls' Hibbertia scandens Lomandra longifolia 'Tanika' Rosmarinus officinalis 'Irene'	Yellow Buttons Silver Falls Kidney Weed Snake Vine Mat Rush Creeping Rosemary	0.3 x 0.5 0.1 x 1.5 0.5 x 2.0 0.8 x 0.8 0.8 x 1.8	140mm 140mm 140mm 140mm	5/m ² or 2/LM 5/m ² or 2/LM 5/m ² or 2/LM 5/m ² or 2/LM	1 1 1 2
Cap DSF Hs LIT RoI TaT	Chrysocephalum apiculatum Dichondra argentea 'Silver Falls' Hibbertia scandens Lomandra longifolia 'Tanika' Rosmarinus officinalis 'Irene' Trachelospermum asiaticum 'Tricolour'	Yellow Buttons Silver Falls Kidney Weed Snake Vine Mat Rush Creeping Rosemary Asiatic Jasmine	0.3 x 0.5 0.1 x 1.5 0.5 x 2.0 0.8 x 0.8 0.8 x 1.8 0.5 x 2.0	140mm 140mm 140mm 140mm 140mm	$5/m^2$ or $2/LM$ $5/m^2$ or $2/LM$ $5/m^2$ or $2/LM$ $5/m^2$ or $2/LM$	1 1 1 2 1
Cap DSF Hs LIT RoI TaT WfM	Chrysocephalum apiculatum Dichondra argentea 'Silver Falls' Hibbertia scandens Lomandra longifolia 'Tanika' Rosmarinus officinalis 'Irene' Trachelospermum asiaticum 'Tricolour' Westringia fruticosa 'Mundi'	Yellow Buttons Silver Falls Kidney Weed Snake Vine Mat Rush Creeping Rosemary	0.3 x 0.5 0.1 x 1.5 0.5 x 2.0 0.8 x 0.8 0.8 x 1.8	140mm 140mm 140mm 140mm	5/m ² or 2/LM 5/m ² or 2/LM 5/m ² or 2/LM 5/m ² or 2/LM	1 1 1 2 1
Cap DSF Hs LIT Rol TaT WfM	Chrysocephalum apiculatum Dichondra argentea 'Silver Falls' Hibbertia scandens Lomandra longifolia 'Tanika' Rosmarinus officinalis 'Irene' Trachelospermum asiaticum 'Tricolour'	Yellow Buttons Silver Falls Kidney Weed Snake Vine Mat Rush Creeping Rosemary Asiatic Jasmine	0.3 x 0.5 0.1 x 1.5 0.5 x 2.0 0.8 x 0.8 0.8 x 1.8 0.5 x 2.0	140mm 140mm 140mm 140mm 140mm	$5/m^2$ or $2/LM$ $5/m^2$ or $2/LM$ $5/m^2$ or $2/LM$ $5/m^2$ or $2/LM$	1 1 1 2 1
Cap DSF Hs LIT RoI TaT WfM	Chrysocephalum apiculatum Dichondra argentea 'Silver Falls' Hibbertia scandens Lomandra longifolia 'Tanika' Rosmarinus officinalis 'Irene' Trachelospermum asiaticum 'Tricolour' Westringia fruticosa 'Mundi'	Yellow Buttons Silver Falls Kidney Weed Snake Vine Mat Rush Creeping Rosemary Asiatic Jasmine	0.3 x 0.5 0.1 x 1.5 0.5 x 2.0 0.8 x 0.8 0.8 x 1.8 0.5 x 2.0	140mm 140mm 140mm 140mm 140mm	$5/m^2$ or $2/LM$ $5/m^2$ or $2/LM$ $5/m^2$ or $2/LM$ $5/m^2$ or $2/LM$	11 12 13 13 13 13 13 13 13 13 13 13 13 13 13
Cap DSF Hs LIT RoI TaT WfM Level 5 PLA	Chrysocephalum apiculatum Dichondra argentea 'Silver Falls' Hibbertia scandens Lomandra longifolia 'Tanika' Rosmarinus officinalis 'Irene' Trachelospermum asiaticum 'Tricolour' Westringia fruticosa 'Mundi' ANT SCHEDULE Betula nigra 'Tropical'	Yellow Buttons Silver Falls Kidney Weed Snake Vine Mat Rush Creeping Rosemary Asiatic Jasmine Creeping Coastal Rosemary	0.3 x 0.5 0.1 x 1.5 0.5 x 2.0 0.8 x 0.8 0.8 x 1.8 0.5 x 2.0 0.5 x 1.5	140mm 140mm 140mm 140mm 140mm	5/m ² or 2/LM 5/m ² or 2/LM	2
Cap DSF Hs LIT RoI TaT WfM Level 5 PLA Trees BnT	Chrysocephalum apiculatum Dichondra argentea 'Silver Falls' Hibbertia scandens Lomandra longifolia 'Tanika' Rosmarinus officinalis 'Irene' Trachelospermum asiaticum 'Tricolour' Westringia fruticosa 'Mundi' ANT SCHEDULE Betula nigra 'Tropical'	Yellow Buttons Silver Falls Kidney Weed Snake Vine Mat Rush Creeping Rosemary Asiatic Jasmine Creeping Coastal Rosemary	0.3 x 0.5 0.1 x 1.5 0.5 x 2.0 0.8 x 0.8 0.8 x 1.8 0.5 x 2.0 0.5 x 1.5	140mm 140mm 140mm 140mm 140mm	5/m ² or 2/LM 5/m ² or 2/LM	11 11 11 11 11 11 11 11 11 11 11 11 11
Cap DSF Hs LIT RoI TaT WfM Level 5 PLA Trees BnT	Chrysocephalum apiculatum Dichondra argentea 'Silver Falls' Hibbertia scandens Lomandra longifolia 'Tanika' Rosmarinus officinalis 'Irene' Trachelospermum asiaticum 'Tricolour' Westringia fruticosa 'Mundi' ANT SCHEDULE Betula nigra 'Tropical' ACCENTS	Yellow Buttons Silver Falls Kidney Weed Snake Vine Mat Rush Creeping Rosemary Asiatic Jasmine Creeping Coastal Rosemary Tropical Birch	0.3 x 0.5 0.1 x 1.5 0.5 x 2.0 0.8 x 0.8 0.8 x 1.8 0.5 x 2.0 0.5 x 1.5	140mm 140mm 140mm 140mm 140mm	5/m ² or 2/LM 5/m ² or 2/LM	11 11 11 11 11 11 11 11 11 11 11 11 11
Cap DSF Hs LIT Rol TaT WfM Level 5 PLA Trees BnT SHRUBS & A	Chrysocephalum apiculatum Dichondra argentea 'Silver Falls' Hibbertia scandens Lomandra longifolia 'Tanika' Rosmarinus officinalis 'Irene' Trachelospermum asiaticum 'Tricolour' Westringia fruticosa 'Mundi' ANT SCHEDULE Betula nigra 'Tropical' ACCENTS Doryanthes excelsa	Yellow Buttons Silver Falls Kidney Weed Snake Vine Mat Rush Creeping Rosemary Asiatic Jasmine Creeping Coastal Rosemary Tropical Birch Gymea Lilly	0.3 x 0.5 0.1 x 1.5 0.5 x 2.0 0.8 x 0.8 0.8 x 1.8 0.5 x 2.0 0.5 x 1.5	140mm 140mm 140mm 140mm 140mm 200L	5/m ² or 2/LM 5/m ² or 2/LM	22 11 11 12 22 11 11 11 11 11 11 11 11 1

Coastal Rosemary

Pig Face

Yellow Buttons

Creeping Rosemary

Creeping Coastal Rosemary

Asiatic Jasmine

Snake Vine

Key Plan:

SITE IMAGE Coveston Developments Pty Ltd

WBG Westringia fruticosa 'Blue Gem'

Cg Carpobrotus glaucascense

Hibbertia scandens

Cap Chrysocephalum apiculatum

Rosmarinus officinalis 'Irene'

Trachelospermum jasminoides

Westringia fruticosa 'Mundi'

Trachelospermum asiaticum 'Tricolour

GRASSES & GROUND COVERS

Landscape Specification & Plant Schedule

Landscape Architects Level 1, 3-5 Baptist Street Proposed Medical Facility 411 - 417 Crown Street

DEVELOPMENT APPLICATION Scale: N/A

LEGEND

For Revised DA

For Revised DA For DA Approval Amendments following client input Amendments following client input

For DA Approval A For DA Approval Issue Revision Description

NP RS 06.12.2021 NP RS 09.11.2021 NP RS 05.11.2021 NP RS 27.10.2021 NP RS 09.07.2021 Drawn Check Date

BS RS 30.06.2023

NP RS 25.10.2022

Redfern NSW 2016 Tel: (61 2) 8332 5600

Wollongong NSW 2500

Job Number:

Drawing Number SS21-4720 L-500 G

200mm

140mm

140mm

140mm

140mm

140mm

As Shown

5/m² or 2/LM

5/m² or 2/LM

5/m² or 2/LM

5/m² or 2/LM

5/m² or 2/LM

5/m² or 2/LM

5/m² or 2/LM

1.5 x 1.3

 0.2×1.5

 0.3×0.5


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0.8 x 1.8


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0.5 x 2.0


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Detail Shrub Accent & Groundcover Planting on Grade 501 1:10



Detail Turf on Even Grade 501 1:10

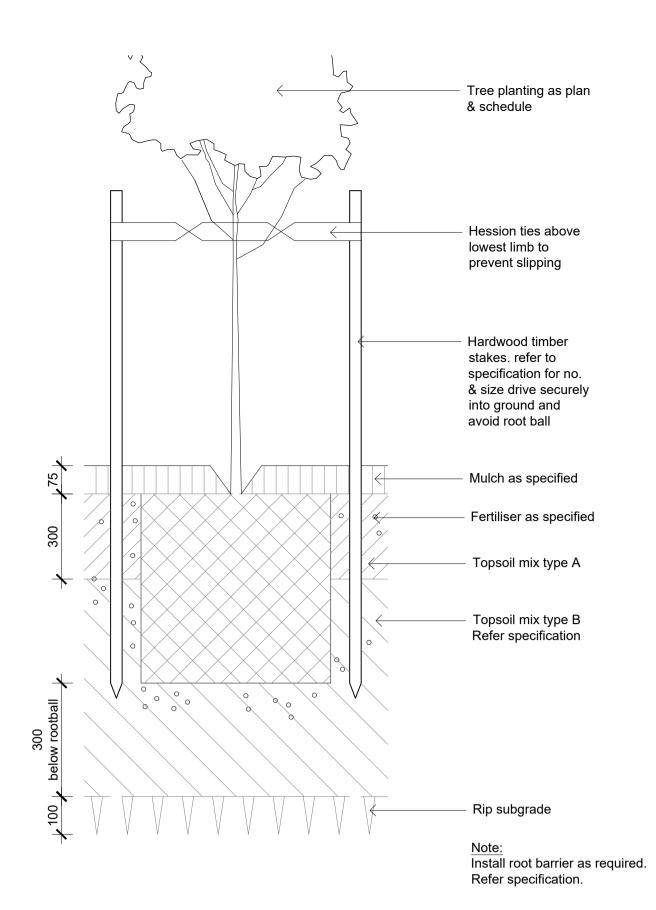NOT FOR CONSTRUCTION
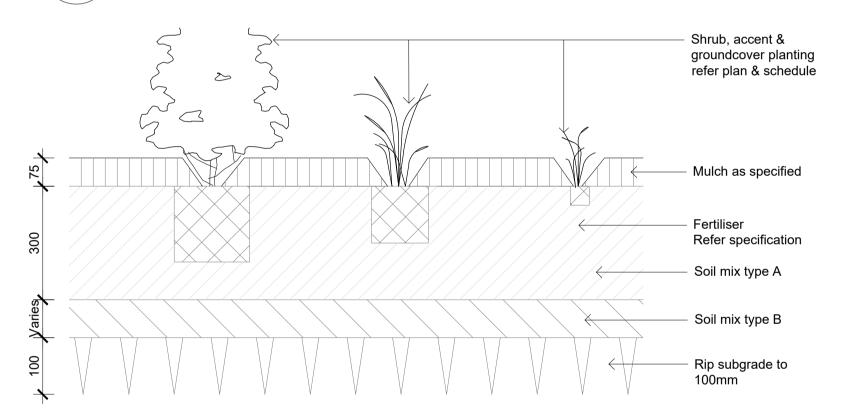
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For Revised DA B For DA Approval A For DA Approval Issue Revision Description

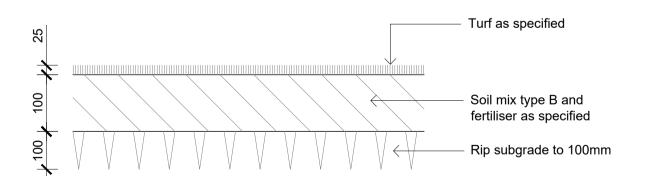
BS RS 30.06.2023 NP RS 06.12.2021 NP RS 09.07.2021 Drawn Check Date

LEGEND

Tree planting as plan & schedule Hession ties above lowest limb to prevent slipping Hardwood timber stakes. refer to specification for no. & size drive securely into ground and avoid root ball Selected mulch (Horizon O) Topsoil mix type A (Horizon A) with fertiliser as specified Topsoil mix type B (Horizon B) with fertiliser as specified. Coarse washed river sand. Drainage cell wrapped with geotextile filter cloth. Suspended concrete slab by others. Screed surface falls to Hydraulic Engineer's details. Install root barrier as required to protect Waterproof membrane by others. adjacent paths, slabs and paving from root

04 Detail 75-200L Tree Planting on Structure 501 1:10

growth damage. Refer plans & specification.

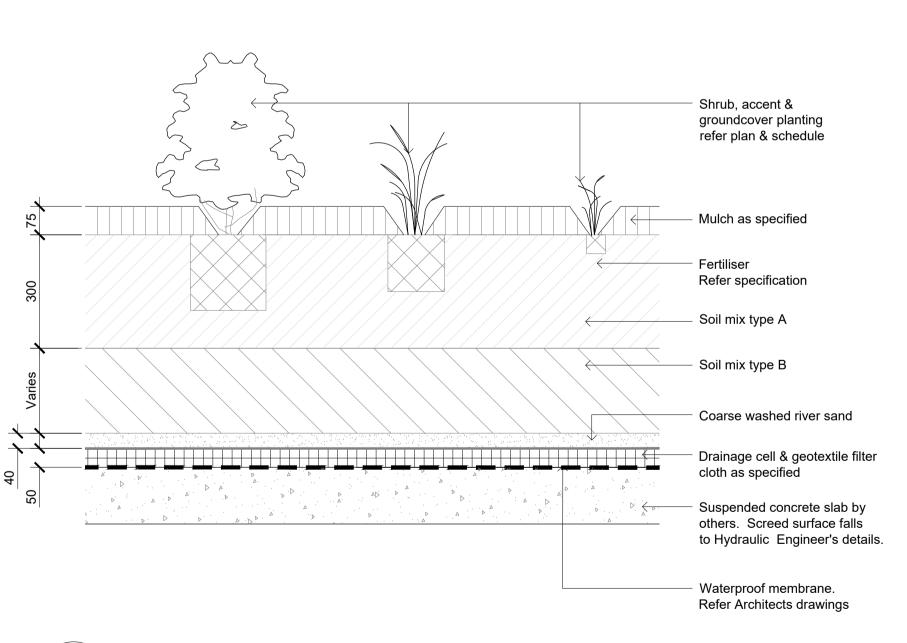


Refer Architects drawings.


05 Detail Shrub Accent & Groundcover Planting on Structure 501 1:10

Refer to plans for adjacent surfaces and edging In-situ reinforced concrete paving slab. Fall to free edges Waterproof membrane Compacted base course Compacted sub-grade to an even surface that allows the finished paving to meet design

Insitu Concrete Paving - On grade

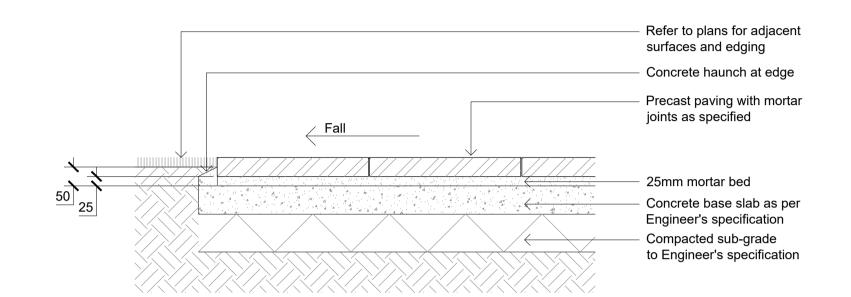

Unit Paving - On Conc. Slab 501 1:10

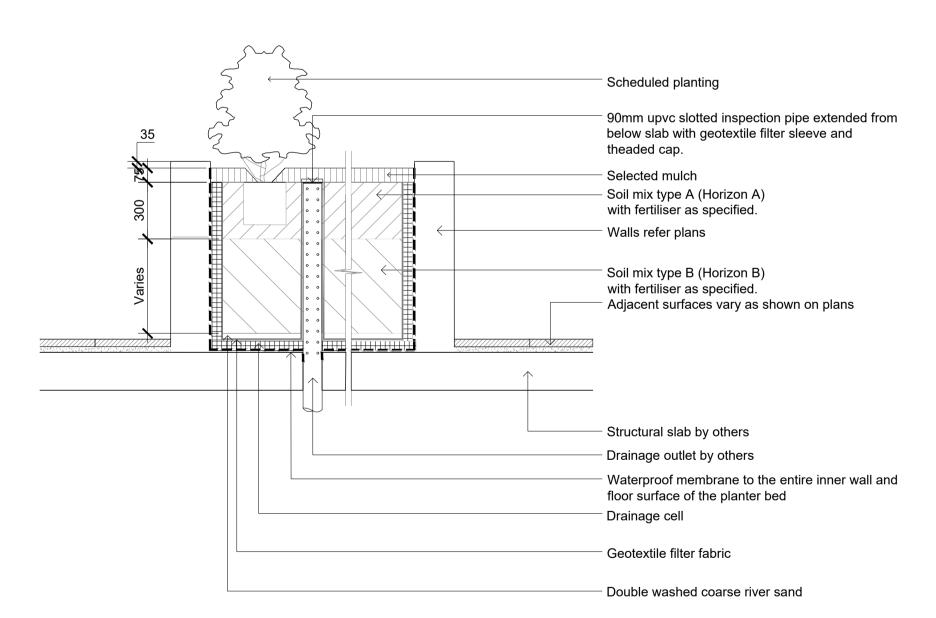

Section - Typical Raised Planter Bed on Structure 501 1:20 Inspection riser pipe

> SITE IMAGE Landscape Architects Level 1, 3-5 Baptist Street Redfern NSW 2016 Australia

Coveston Developments Pty Ltd

Landscape Details

Proposed Medical Facility 411 - 417 Crown Street,

DEVELOPMENT APPLICATION

Scale: Varies - As Shown Job Number: Drawing Number:


SS21-4720

Key Plan:


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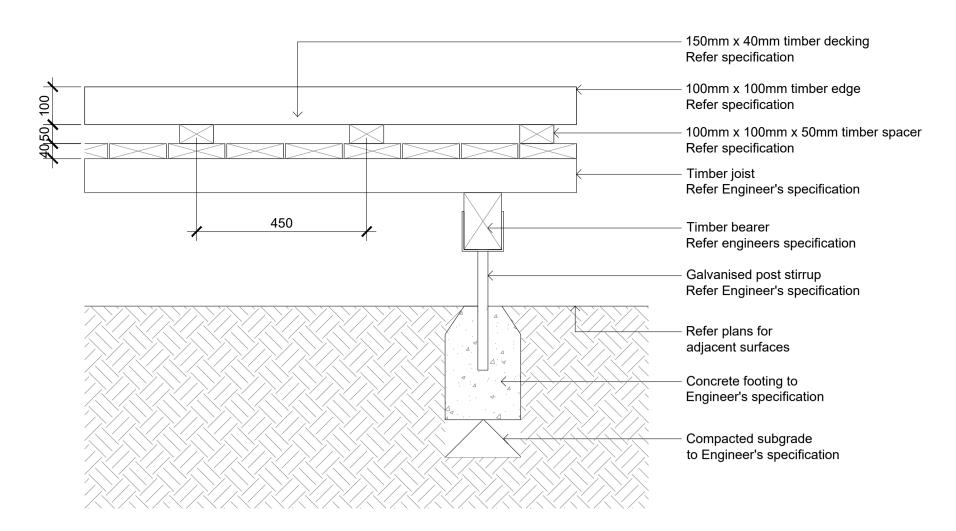
L-501 C




Section - Typical Raised Planter Bed

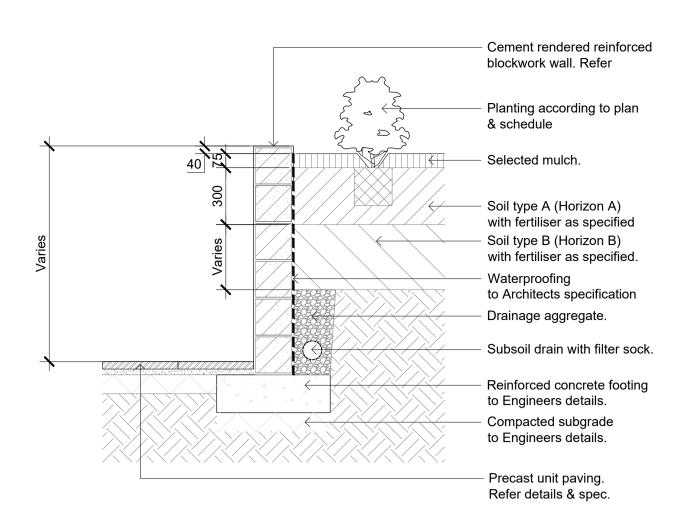

02 Level 1 Terrace Bench
502 1:20
SECTION SECTION

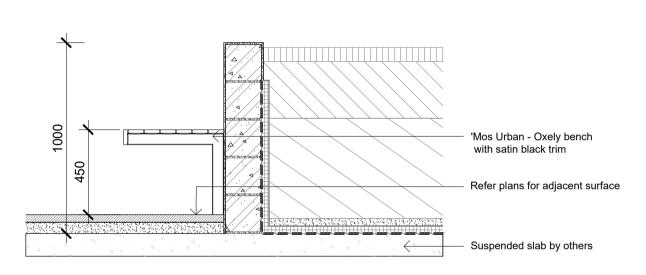

03 RAISED TIMBER DECK - SECTION AA 502 SCALE 1:10

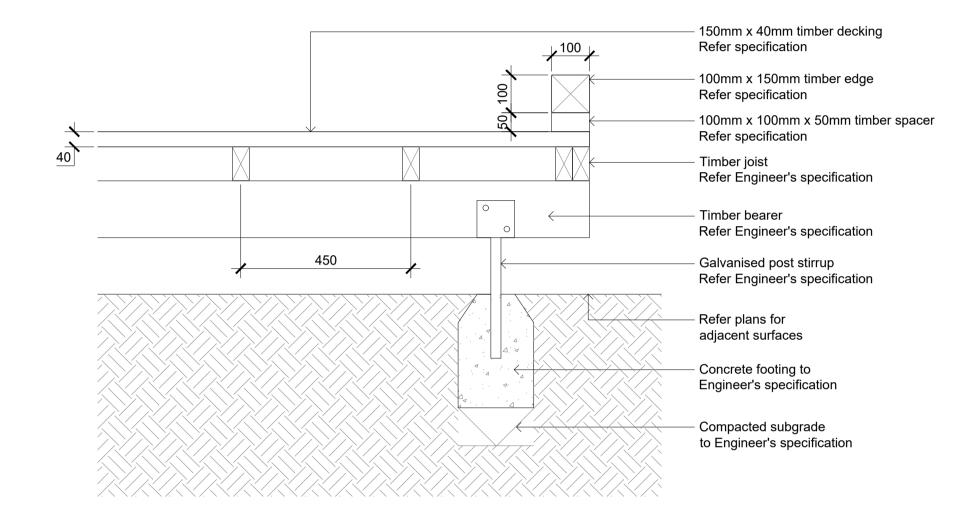

RAISED TIMBER DECK - SECTION BB 502 SCALE 1:10

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C For Revised DA B For DA Approval

BS RS 30.06.2023 NP RS 06.12.2021 NP RS 09.07.2021 A For DA Approval Drawn Check Date Issue Revision Description

LEGEND

Key Plan:

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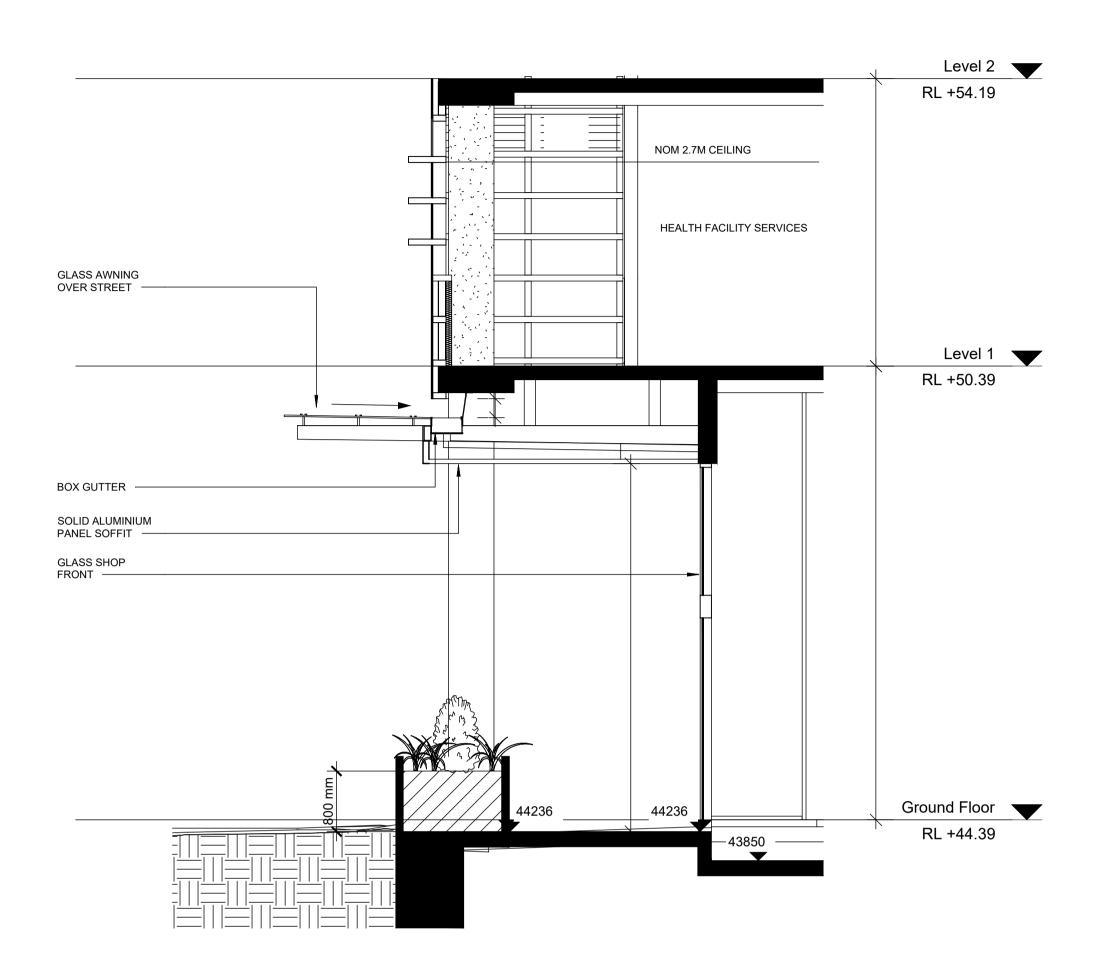
Landscape Details

Proposed Medical Facility 411 - 417 Crown Street, Wollongong NSW 2500


DEVELOPMENT APPLICATION

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SS21-4720 L-502 C





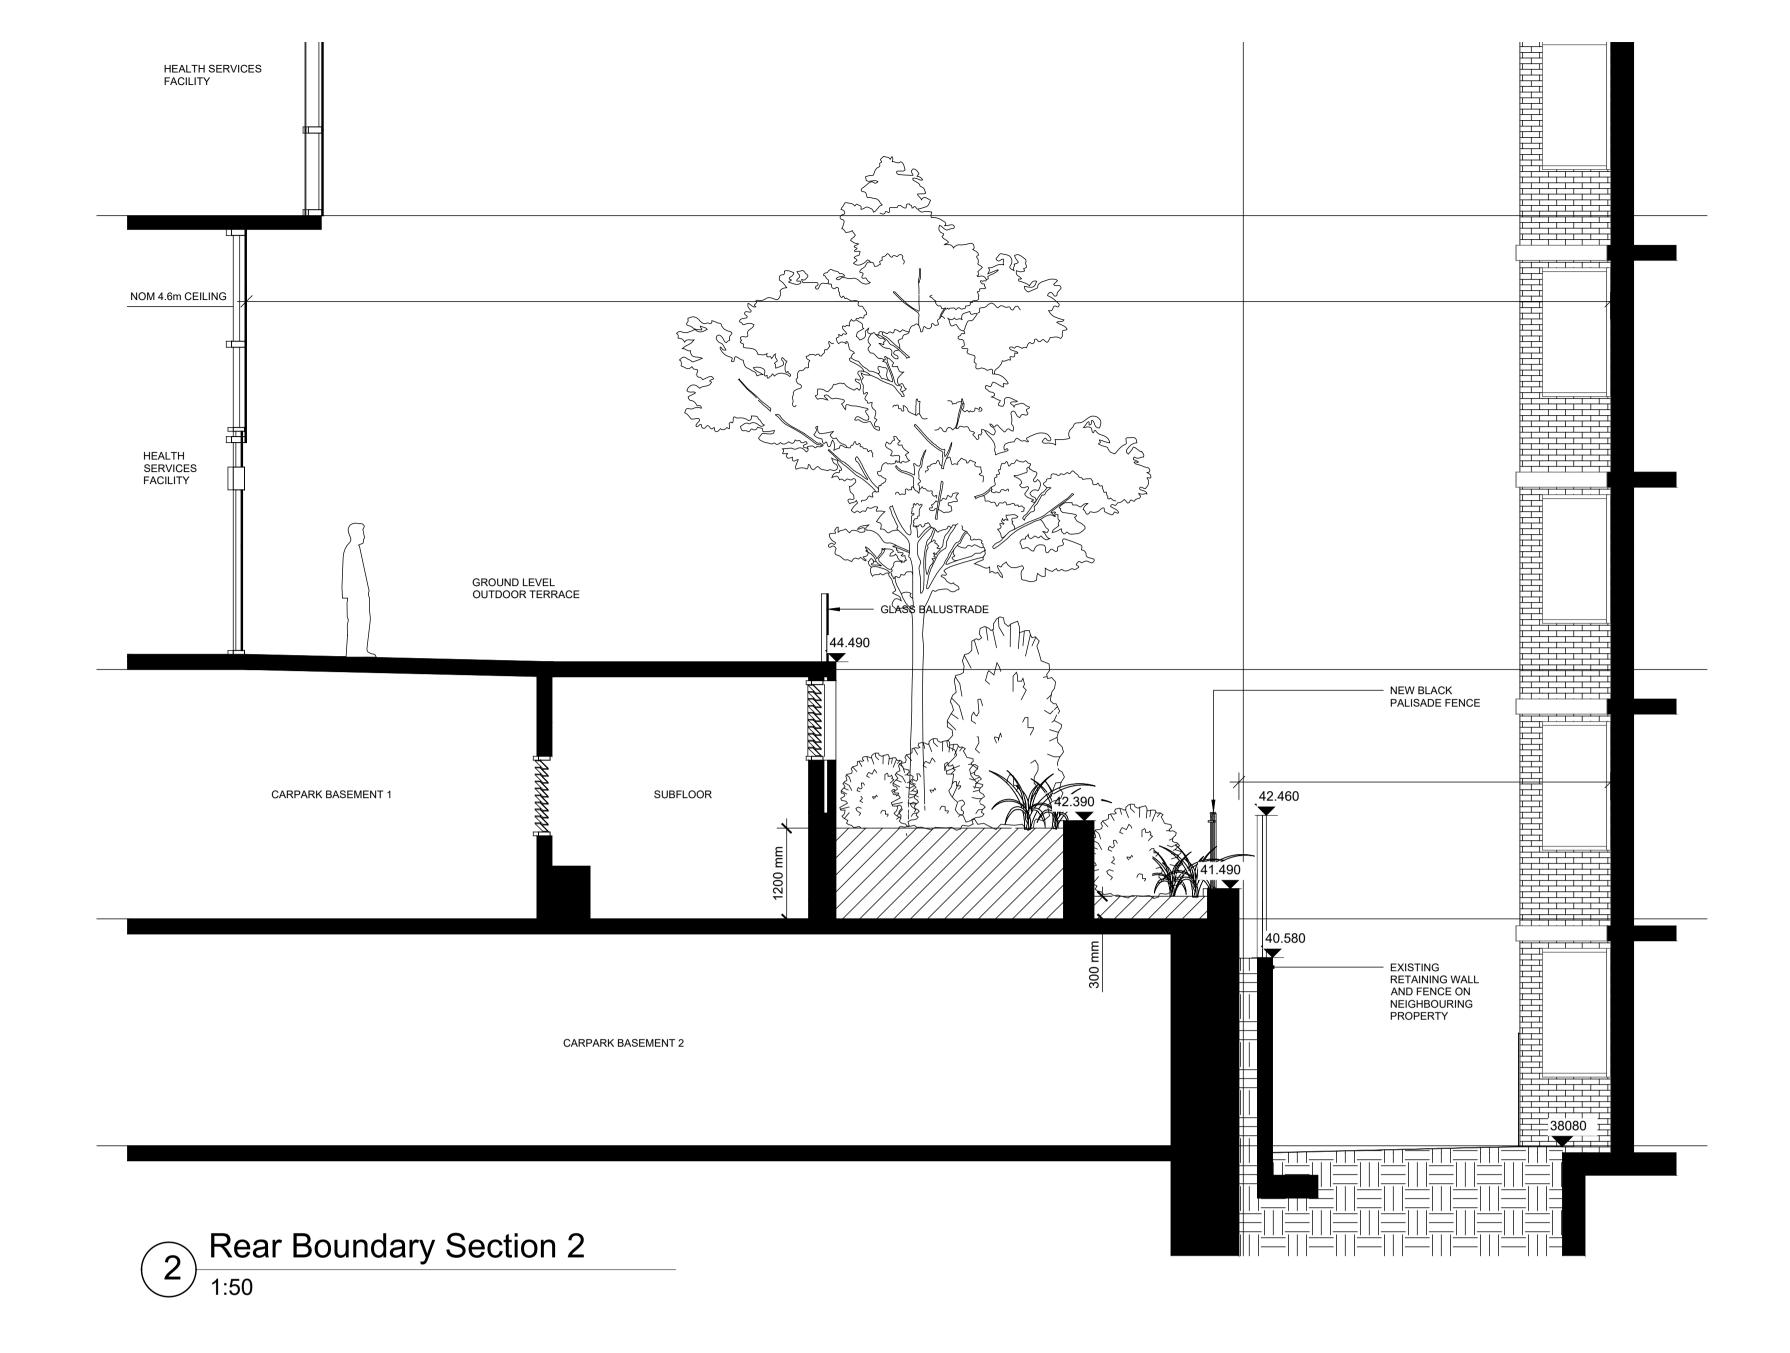

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LEGEND

Key Plan:

SITE IMAGE Client:

Coveston Developments Pty Ltd

Landscape Sections

Project:
Proposed Medical Facility
411 - 417 Crown Street,
Wollongong NSW 2500

Landscape Architects

Level 1, 3-5 Baptist Street Redfern NSW 2016 Australia

Tel: (61 2) 8332 5600

Fax: (61 2) 9698 2877

DEVELOPMENT APPLICATION


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Job Number: Drawing Number: Issue:

SS21-4720 L-700 A

A For Revised DA BS RS 30.06.2023

Issue Revision Description Drawn Check Date

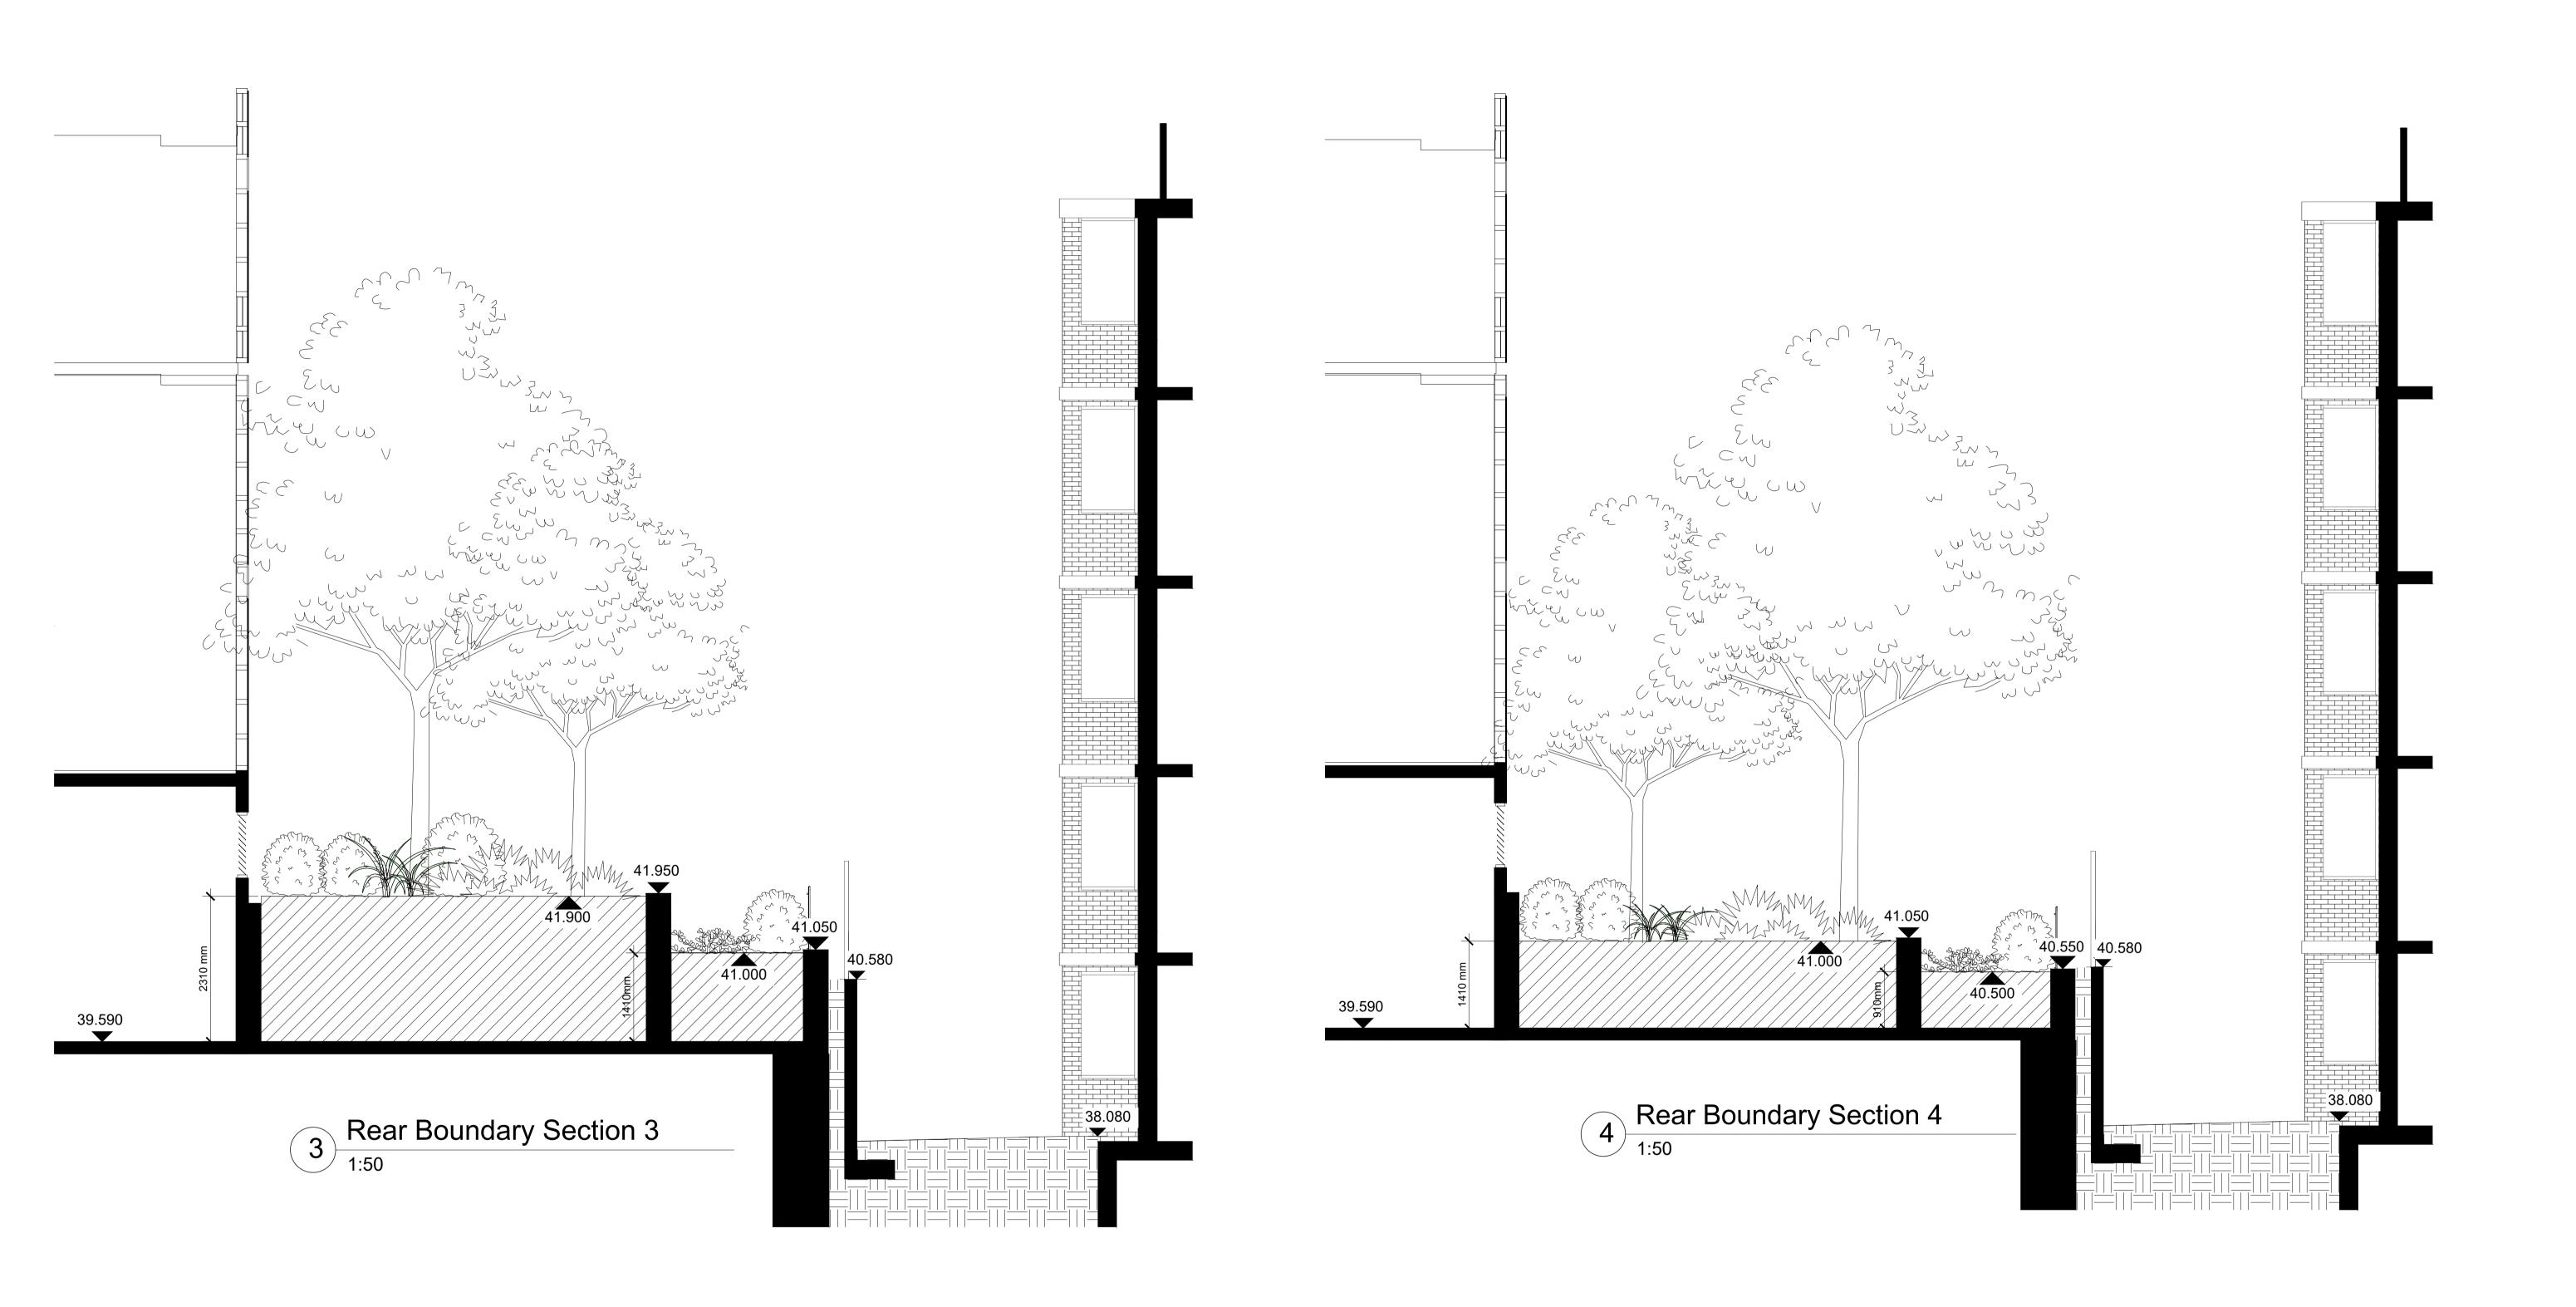

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Landscape Architects

Level 1, 3-5 Baptist Street
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Australia

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SITE IMAGE Client:

Coveston Developments Pty Ltd

Landscape Sections

Job Number:

SS21-4720

Project:
Proposed Medical Facility
411 - 417 Crown Street,
Wollongong NSW 2500

DEVELOPMENT APPLICATION

Scale: Varies - As Shown


L-701 A


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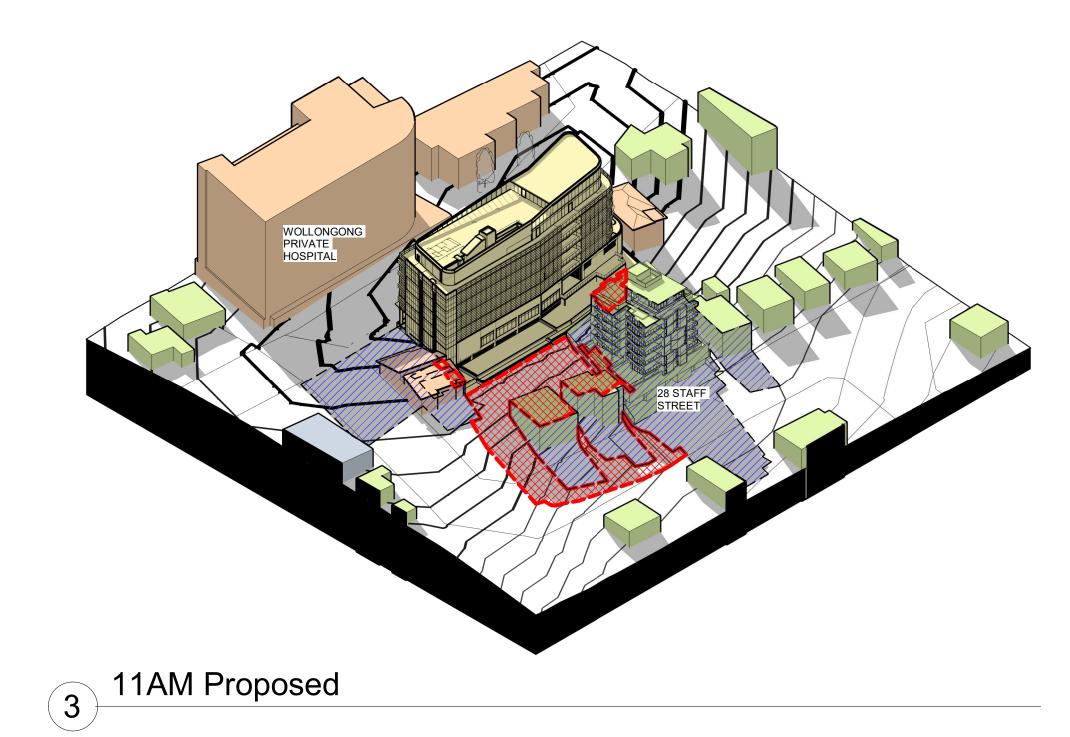
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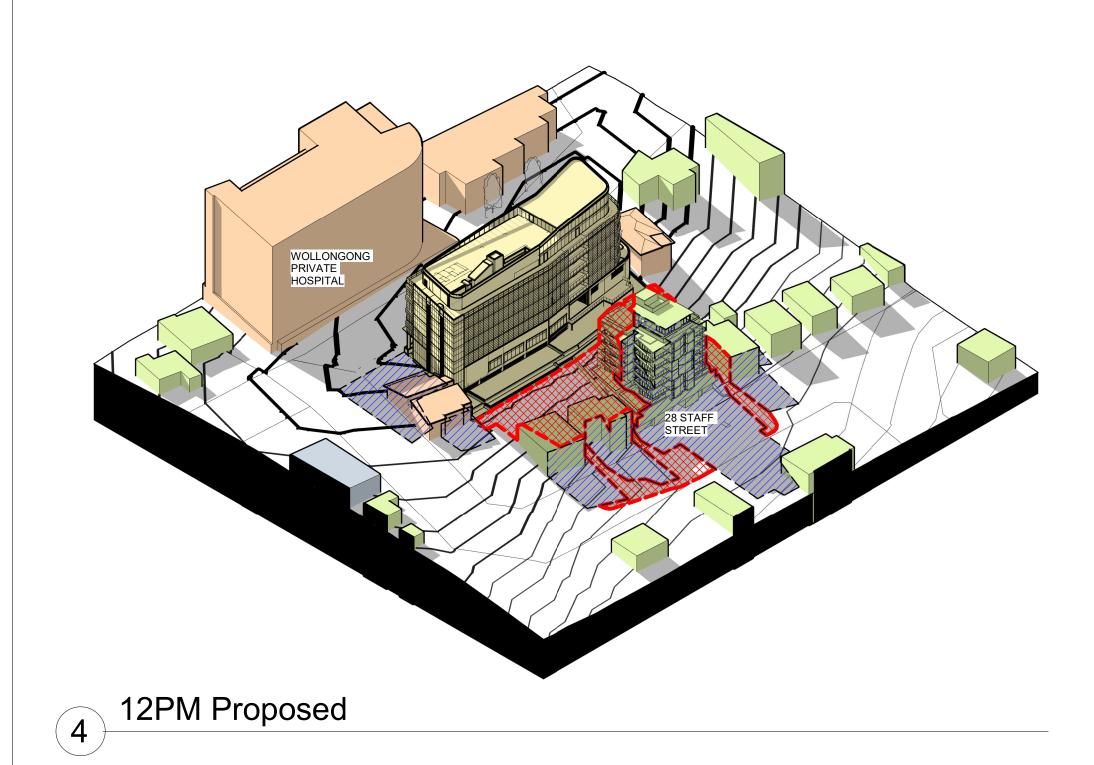
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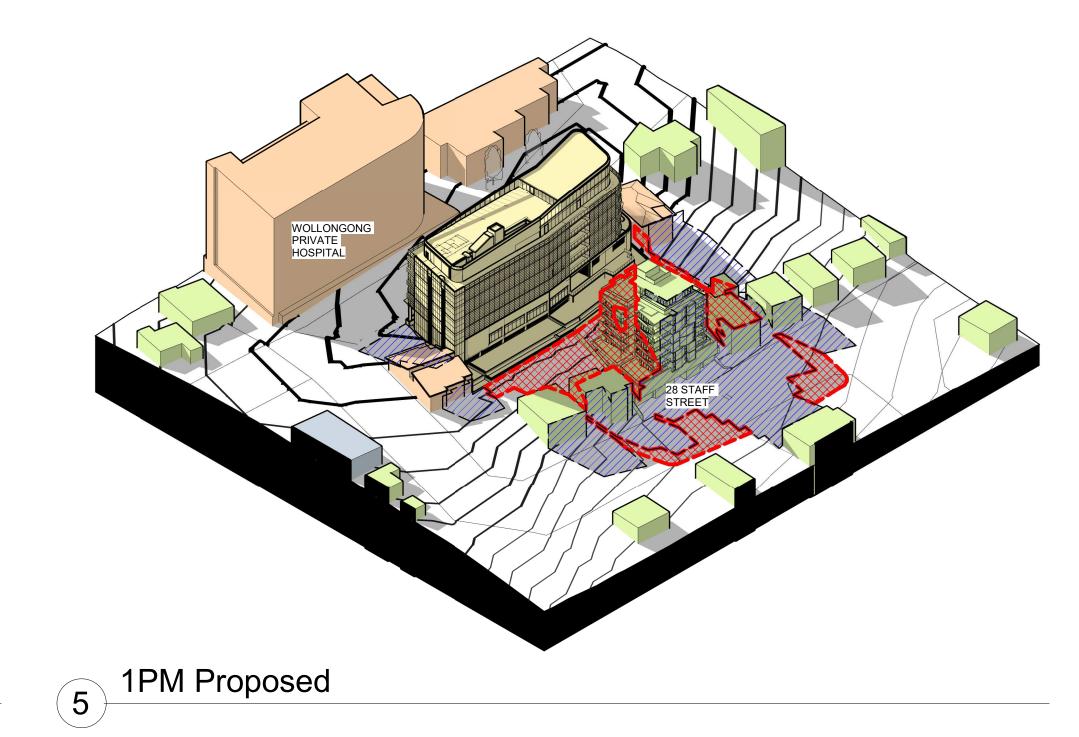
3D SOLAR ANALYSIS










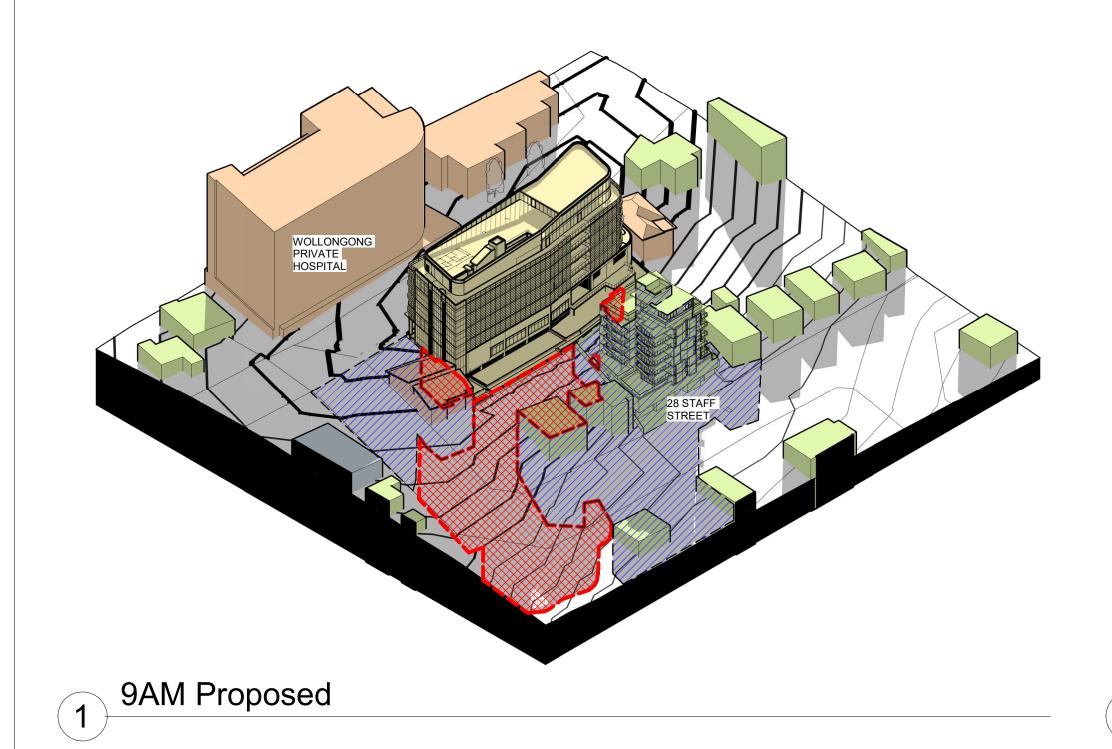

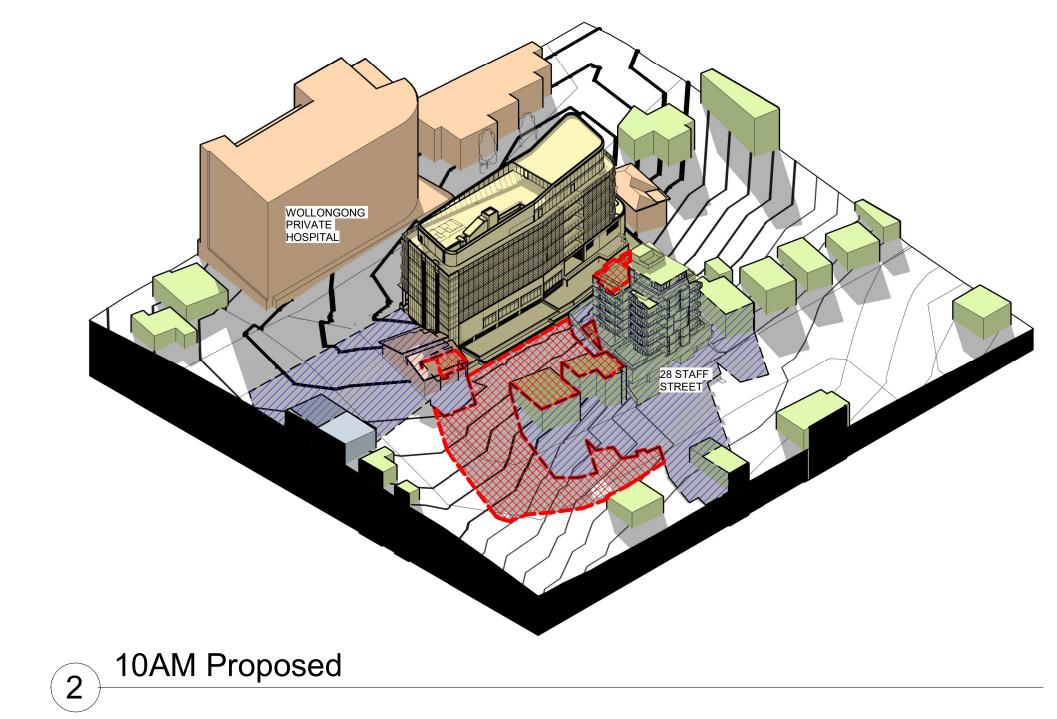

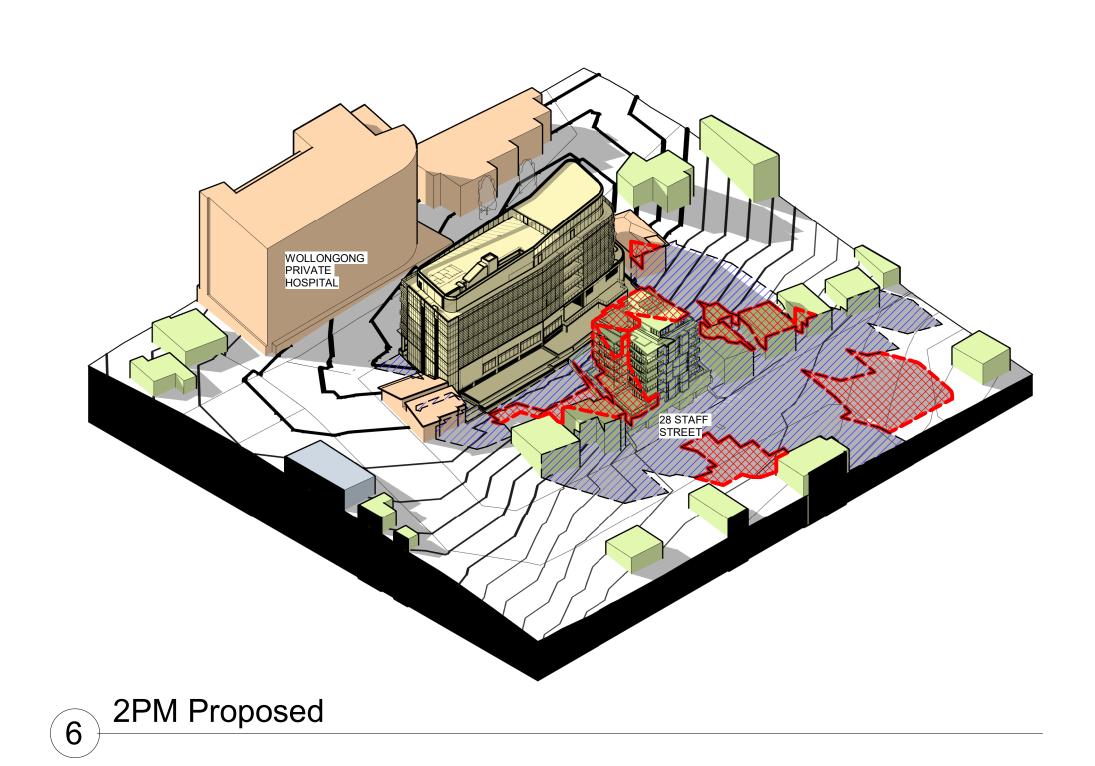

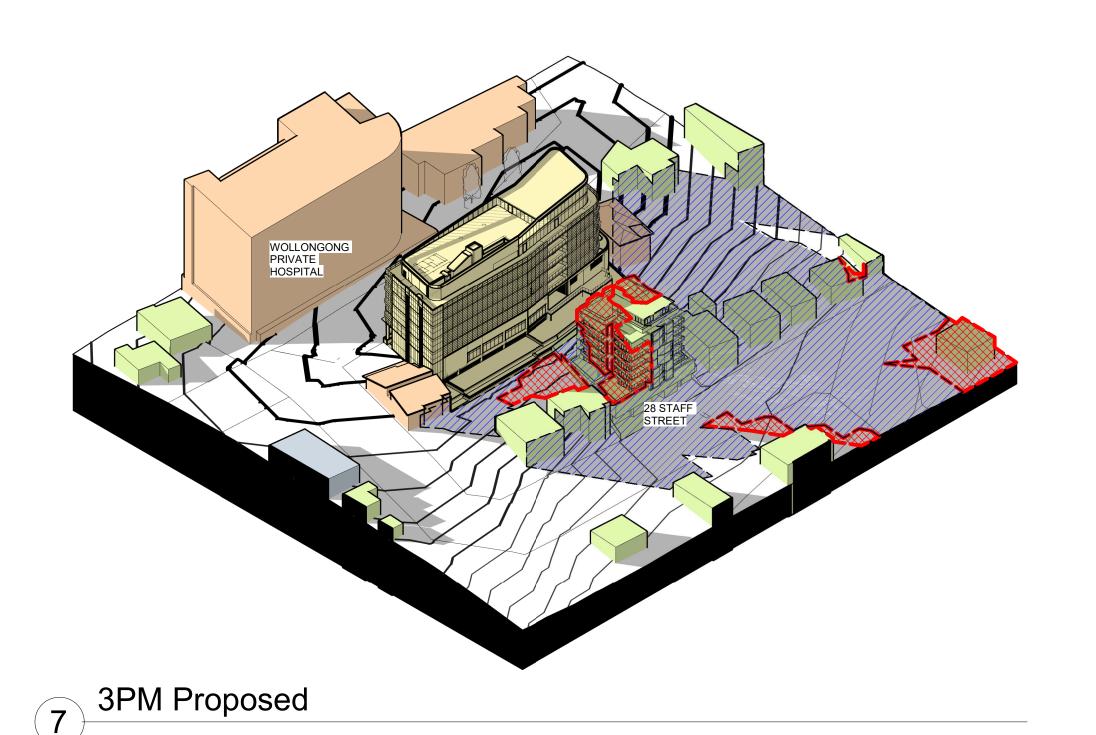

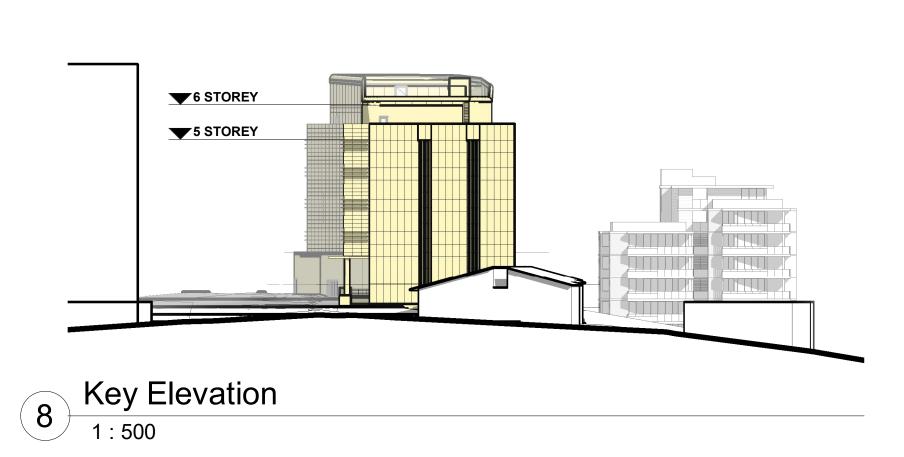

DRAWING TITLE 3D Solar Analysis

CLIENT
Coveston Developments Pty Ltd

PROJECT TITLE

Proposed Medical Facility 411-417 Crown Street, Wollongong

ANTHONY VAVAYIS +ASSOCIATES ARCHITECTS DESIGNERS PLANNERS

24 LIME STREET KING STREET WHARF SYDNEY NSW 2000 E: admin@avaarchitects.com.au T: 02 9290 1810 F: 02 9290 1860 W: www.avaarchitects.com.au

P: 20/26A LIME STREET KING STREET WHARF SYDNEY NSW 2000 ANTHONY VAVAYIS & ASSOCIATES PTY. LTD. ACN 069 737 935 NOMINATED ARCHITECT - ANTHONY VAVAYIS NO.5243

NOTE


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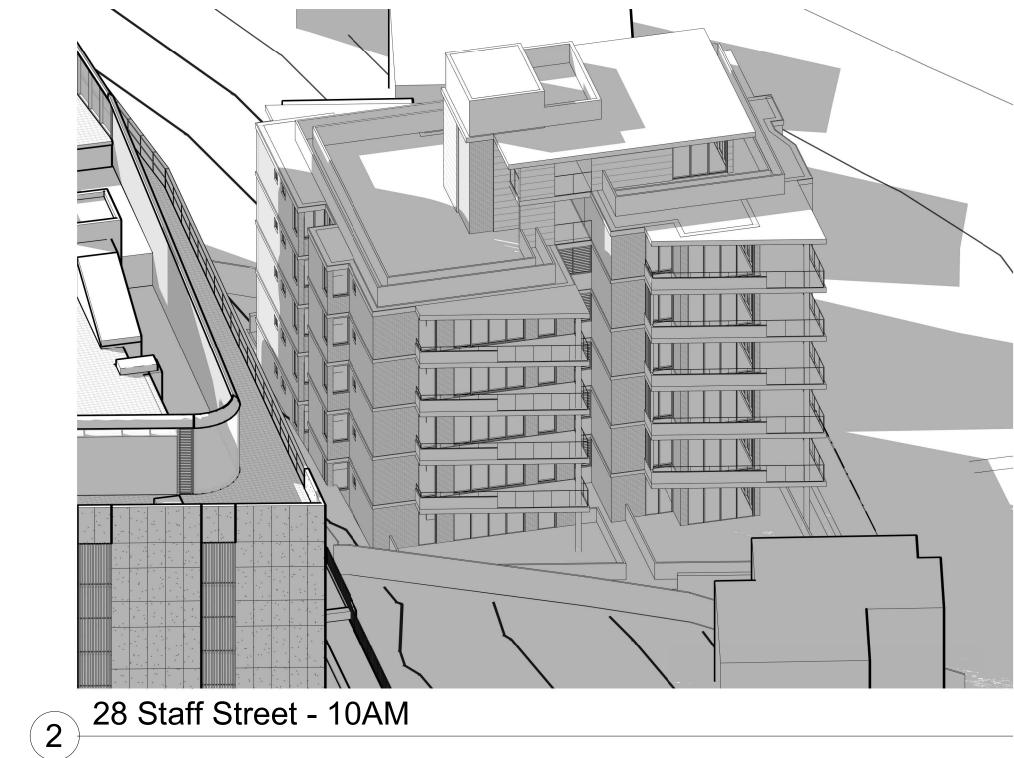
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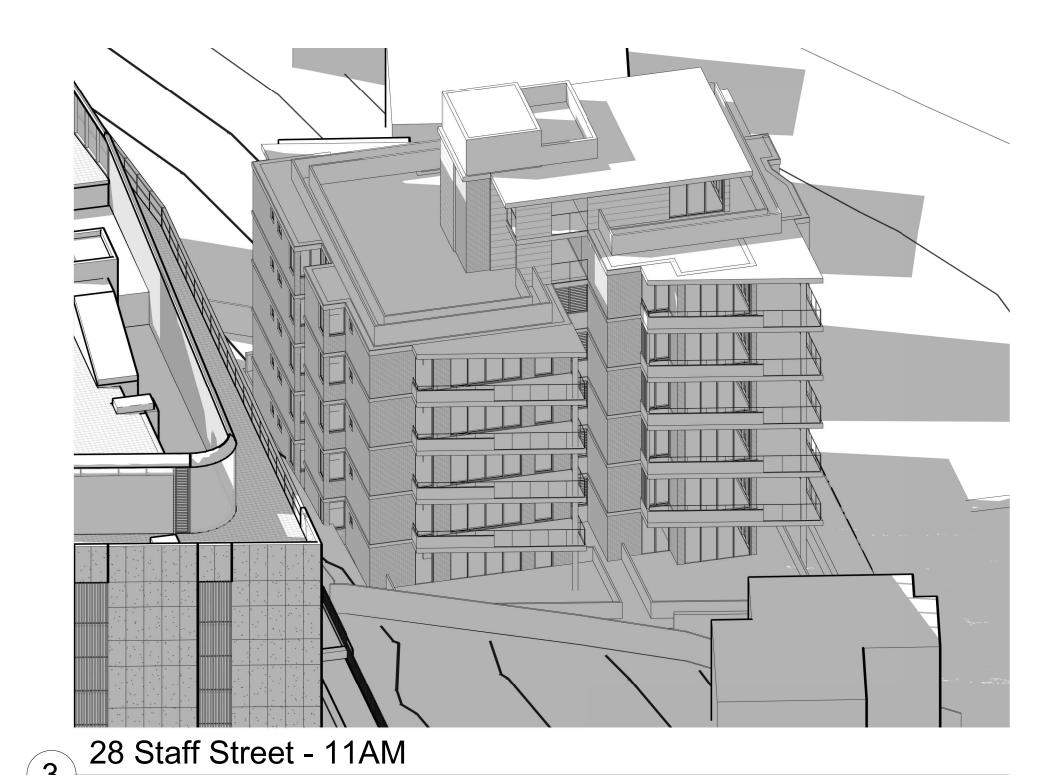
SHADOWS CAST BY PROPOSED BUILDINGS


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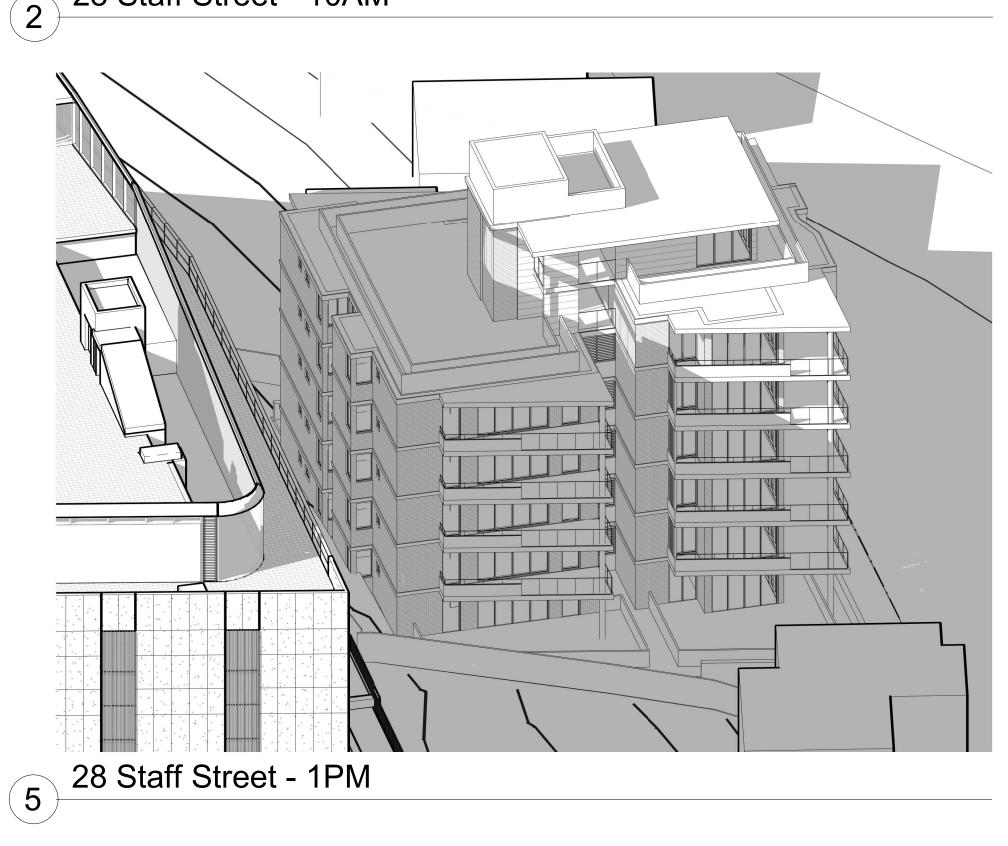
3D SOLAR ANALYSIS - 28-30 STAFF STREET










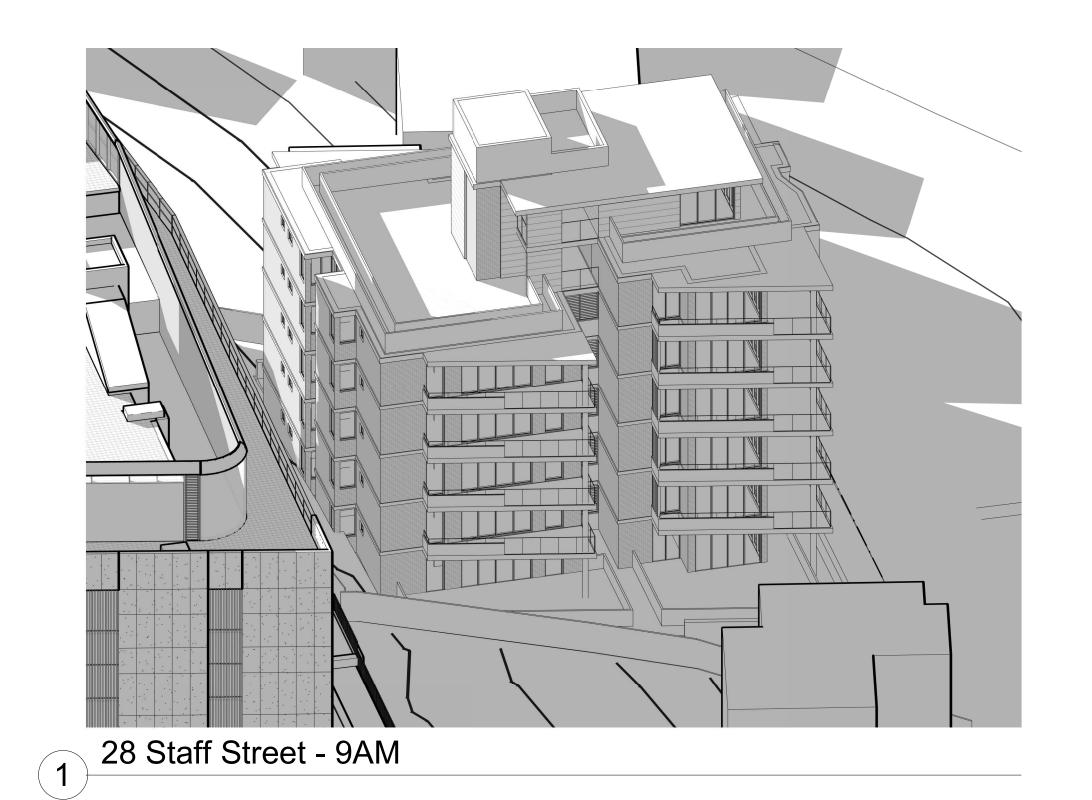

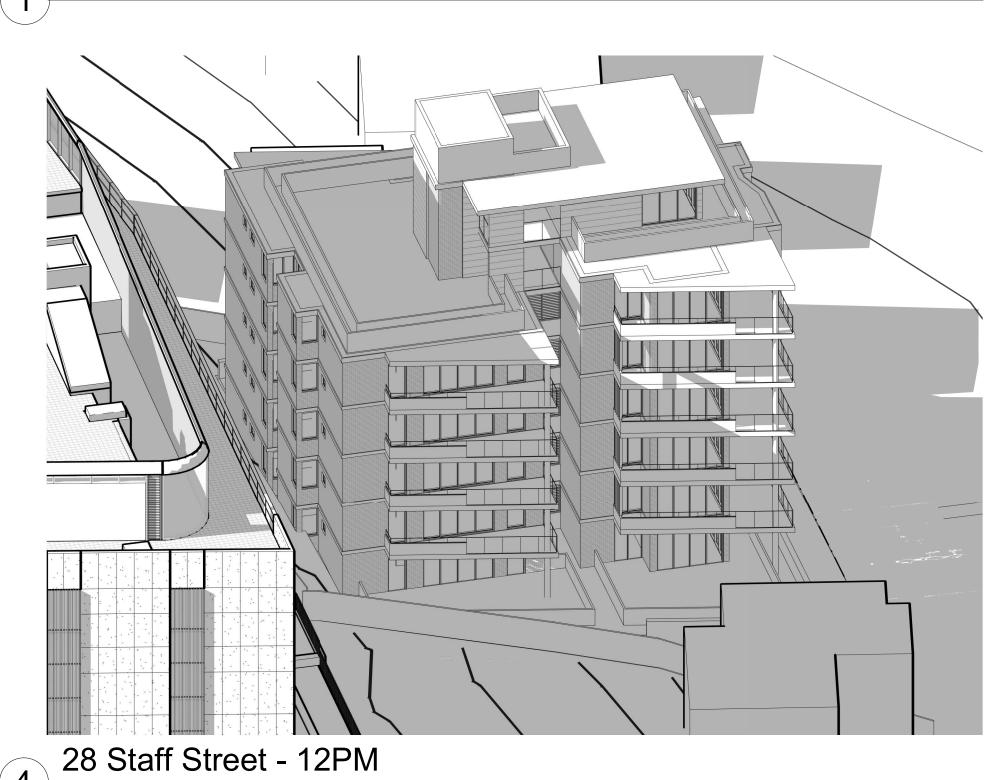

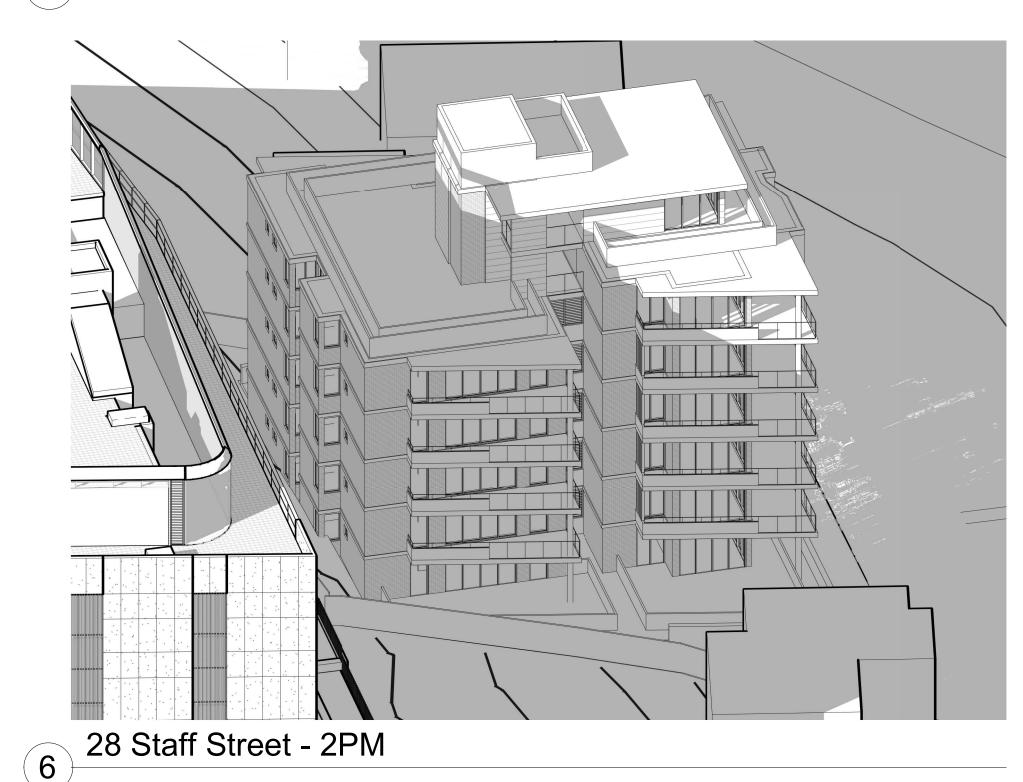

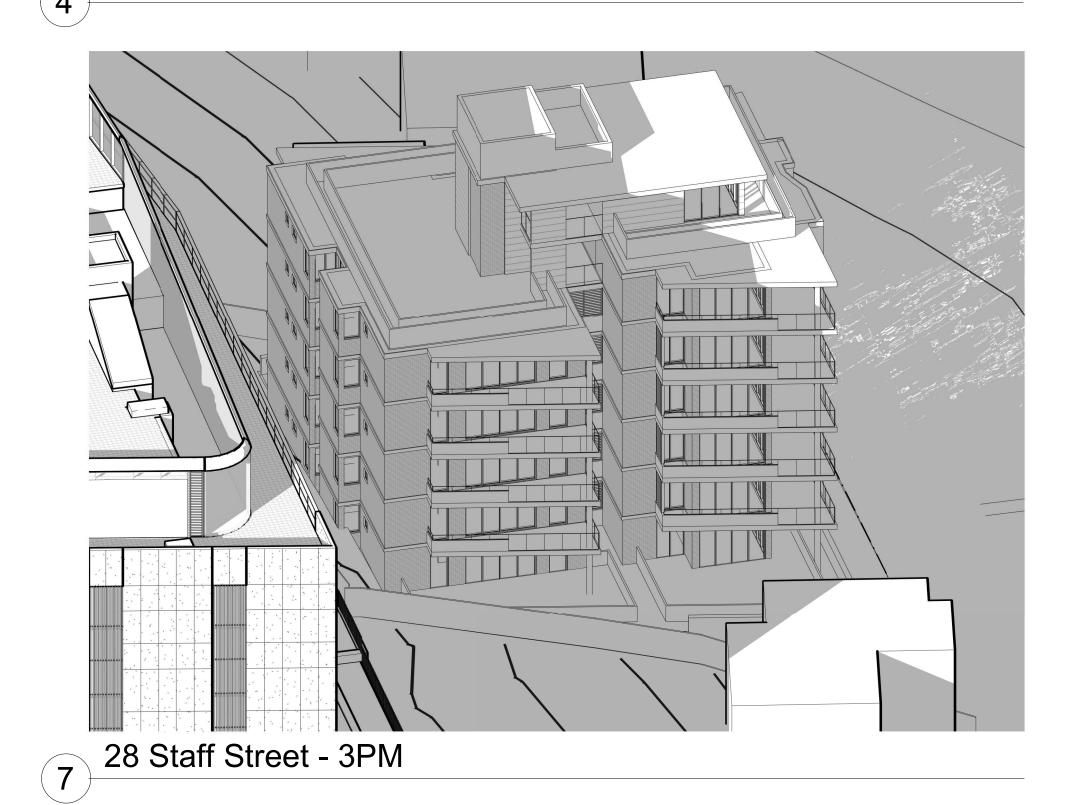

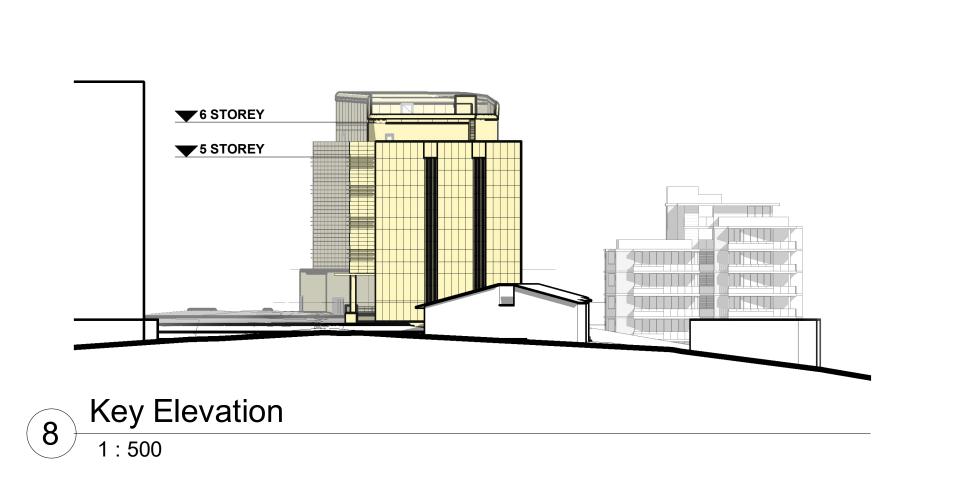

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F: 02 9290 1860 W: www.avaarchitects.com.au P: 20/26A LIME STREET KING STREET WHARF SYDNEY NSW 2000 ANTHONY VAVAYIS & ASSOCIATES PTY. LTD. ACN 069 737 935 NOMINATED ARCHITECT - ANTHONY VAVAYIS NO.5243 PROJECT TITLE Proposed Medical Facility 411-417 Crown Street, Wollongong

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3D Solar Analysis - 28 Staff Street

DA3001.2





3 PM Proposed
1:500





WOLLONGONG PRIVATE HOSPITAL CROWN STREET STAFF STREET

2 12PM Proposed 1:500

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PROJECT TITLE Proposed Medical Facility 411-417 Crown Street, Wollongong

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DRAWING TITLE Shadow Analysis

SCALE @ B1 As indicated DATE MAY 2020